PROJECT	DESIGNATION
1800208	1800208
CONTRACT	
R-41465	

INDIANA DEPARTMENT OF TRANSPORTATION



RIGHT-OF-WAY PLANS


ROUTE: SR 46 AT SMITH ROAD

PROJECT NO.

1800208 P.E. 1800208 R/W 1800208 CONST.


Project Description:

Intersection Improvement project at SR 46 and Smith Road, located in the City of Bloomington, Indiana Section 35, T-9-N, R-1-W and Section 36, T-9-N, R-1-W, Bloomington Township, Monroe County, Indiana Section 2, T-8-N, R-1-W and Section 1, T-8-N, R-1-W, Perry Township, Monroe County, Indiana

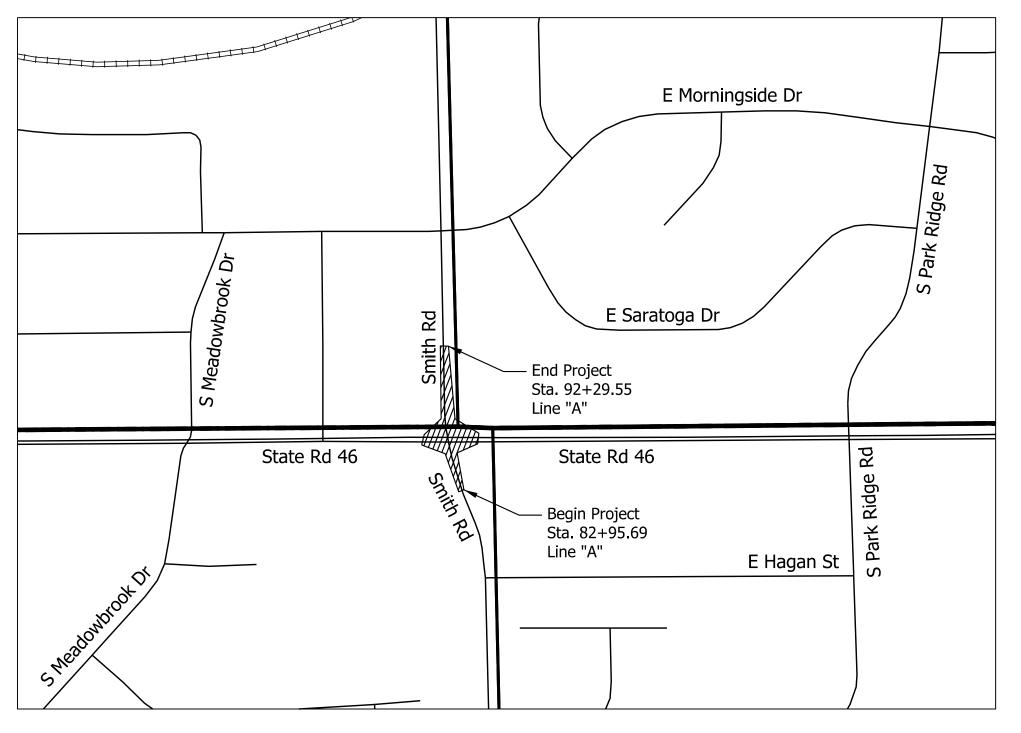

Note to Reviewer: Right-of-Way
Plans Not for Construction

TRAFFI	C DATA	Smith Rd	SR 46
A.A.D.T.	(2018)	6,380 V.P.D.	14,785 V.P.D.
A.A.D.T.	(2043)	7,576 V.P.D.	17,567 V.P.D.
D.H.V	(2043)	687 V.P.H.	1,191 V.P.H.
DIRECTIONAL DISTR	RIBUTION	50 %	50 %
TRUCKS		5.26 % A.A.D.T.	5.01% A.A.D.T.
		3.72 % D.H.V.	4.34% D.H.V.
DESIGN	N DATA	Smith Rd	SR 46
DESIGN SPEED		30 м.р.н.	40 M.P.H.
PROJECT DESIGN CF	RITERIA	3R (NON-FREEWAY)	3R (NON-FREEWAY)
FUNCTIONAL CLASS	IFICATION	MAJOR COLLECTOR (URBAN)	PRINCIPAL ARTERIAL (URBAN)
RURAL/URBAN		URBAN (INTERMEDIATE)	URBAN (INTERMEDIATE)
TERRAIN		LEVEL	LEVEL

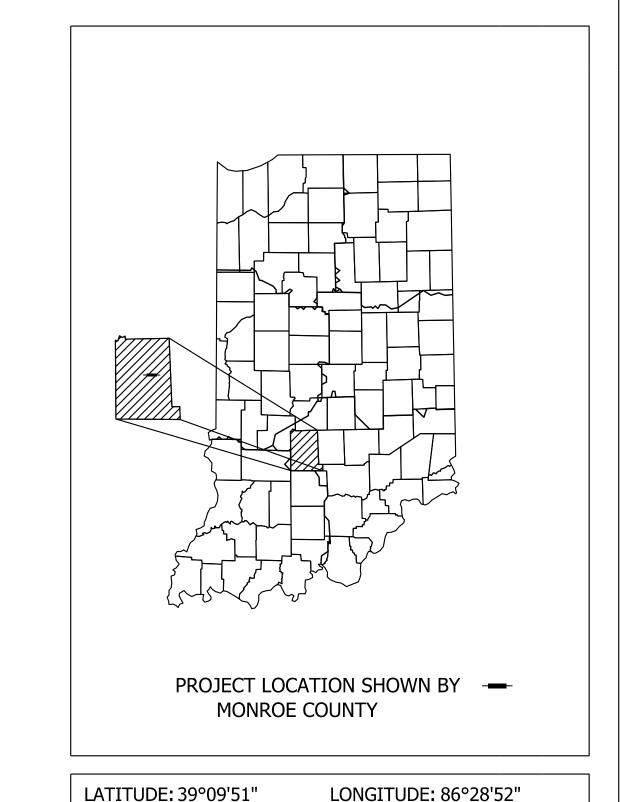

	2011011002100 2032		
GROSS LENGTH:	0.18 MI.		
NET LENGTH:	0.18 MI.		
MAX. GRADE:	5.0_ %		

RIGHT-OF-WAY PLANS APRIL 22, 2022

INDIANA DEPARTMENT OF TRANSPORTATION STANDARD SPECIFICATIONS DATED 2021 TO BE USED WITH THESE PLANS

BRIDGE FILE

N/A

1800208

SHEETS

PROJECT

1800208

of

DESIGNATION

SURVEY BOOK
Electronic
CONTRACT
R-41465

Engineers and Consultants

8790 PURDUE ROAD

INDIANAPOLIS, IN 46268-6128

PHONE: (317) 298-4500

Project Area

Copyright CMT, Inc.

NOT FOR TON

Location Map

Monroe County

Scale: 1" = 4,000'

PLANS
PREPARED BY:

CRAWFORD, MURPHY & TILLY INC.

CERTIFIED BY:

APPROVED
FOR LETTING:

INDIANA DEPARTMENT OF TRANSPORTATION

(317) 298-4500
PHONE NUMBER

6/3/2022
DATE

UTILITIES

Duke Energy- Eletric Cindy Rowland 390 N. Main Street Martinsville, IN 46151 (317) 776-5341 cindy.rowland@duke-energy.com

Smithville Communications
Kimberly Pitcher
1600 W. Temperance Street
Ellettsville, IN 47429
(812) 935-2315
kimberly.pitcher@smithville.com

Vectren Energy- Gas Jon Eastham 1800 W. 26th Street Muncie, IN 47302 (765) 287-2119 publicproject@vectren.com Zayo Bandwidth Waylon Higgins 8209 Castlegate Drive Indianapolis, IN 46256 (765) 341-1199 waylon.higgins@zayo.com

Bloomington Utilities
Phil Peden
600 E. Miller Road
Bloomington, IN 47402
(812) 349-3634
pedenp@bloominton.in.gov

Duke Energy- Electric Dewayne Wright 390 N. Main Street Martinsville, IN 46151 (317) 838-2044 DEI-Tline-Coord@duke-energy.com AT&T Distribution Mattew Spindler 240 N. Meridian Street Indianapolis, IN 46204 (317) 265-3050 ms4822@att.com

Bloomington Utilities
Jane Fleig
600 E. Miller Road
Bloomington, IN 47402
(812) 349-3631
fleigi@bloomington.in.gov

Comcast Cable Rhonda Dalton 688 Industrial Drive Elmhurst, IL 60126 (224) 229-5863 rhonda.dalton@comcast.com

REVISIONS 1. 2. 3. 4. 5.

GENERAL NOTES

- 1. All earth shoulders, median areas, and cut and fill slopes shall be sodded.
- 2. The contractor shall ensure that safe access is maintained to all residences and businesses during all phases of construction.
- 3. All removal items not paid for directly will be included in the lump sum cost of clearing right of way, per Standard Specifications 201 and 202.
- 4. Existing curb types may vary at streets. Contractor shall inspect curb prior to beginning work to assure proper fit and transition.
- 5. Contractor to ensure that positive drainage is maintained at all intersections and along curb and gutter flowlines after the completion of curb ramp construction.

SHEET NO.	DRAWINGS INDEX
1	Title Sheet
2	Index Sheet
3 - 5	Location Control Route Survey
6	Plat No. 1
7	Alignment Information Sheet
8-12	Typical Cross Section
13-20	Plan And Profile
21	Approach Table

R/W INDEX


NOT FOR TON

•	RECOMMENDED FOR APPROVAL		DESIGN ENGINEER	DATE
	DESIGNED: CMP	6/3/2022	DRAWN: \$DWNBY\$	6/3/2022
	CHECKED: CMR	6/3/2022	CHECKED: \$DWNCHKBY\$	6/3/2022

R-41465

1800208

Etica No. 180097.07

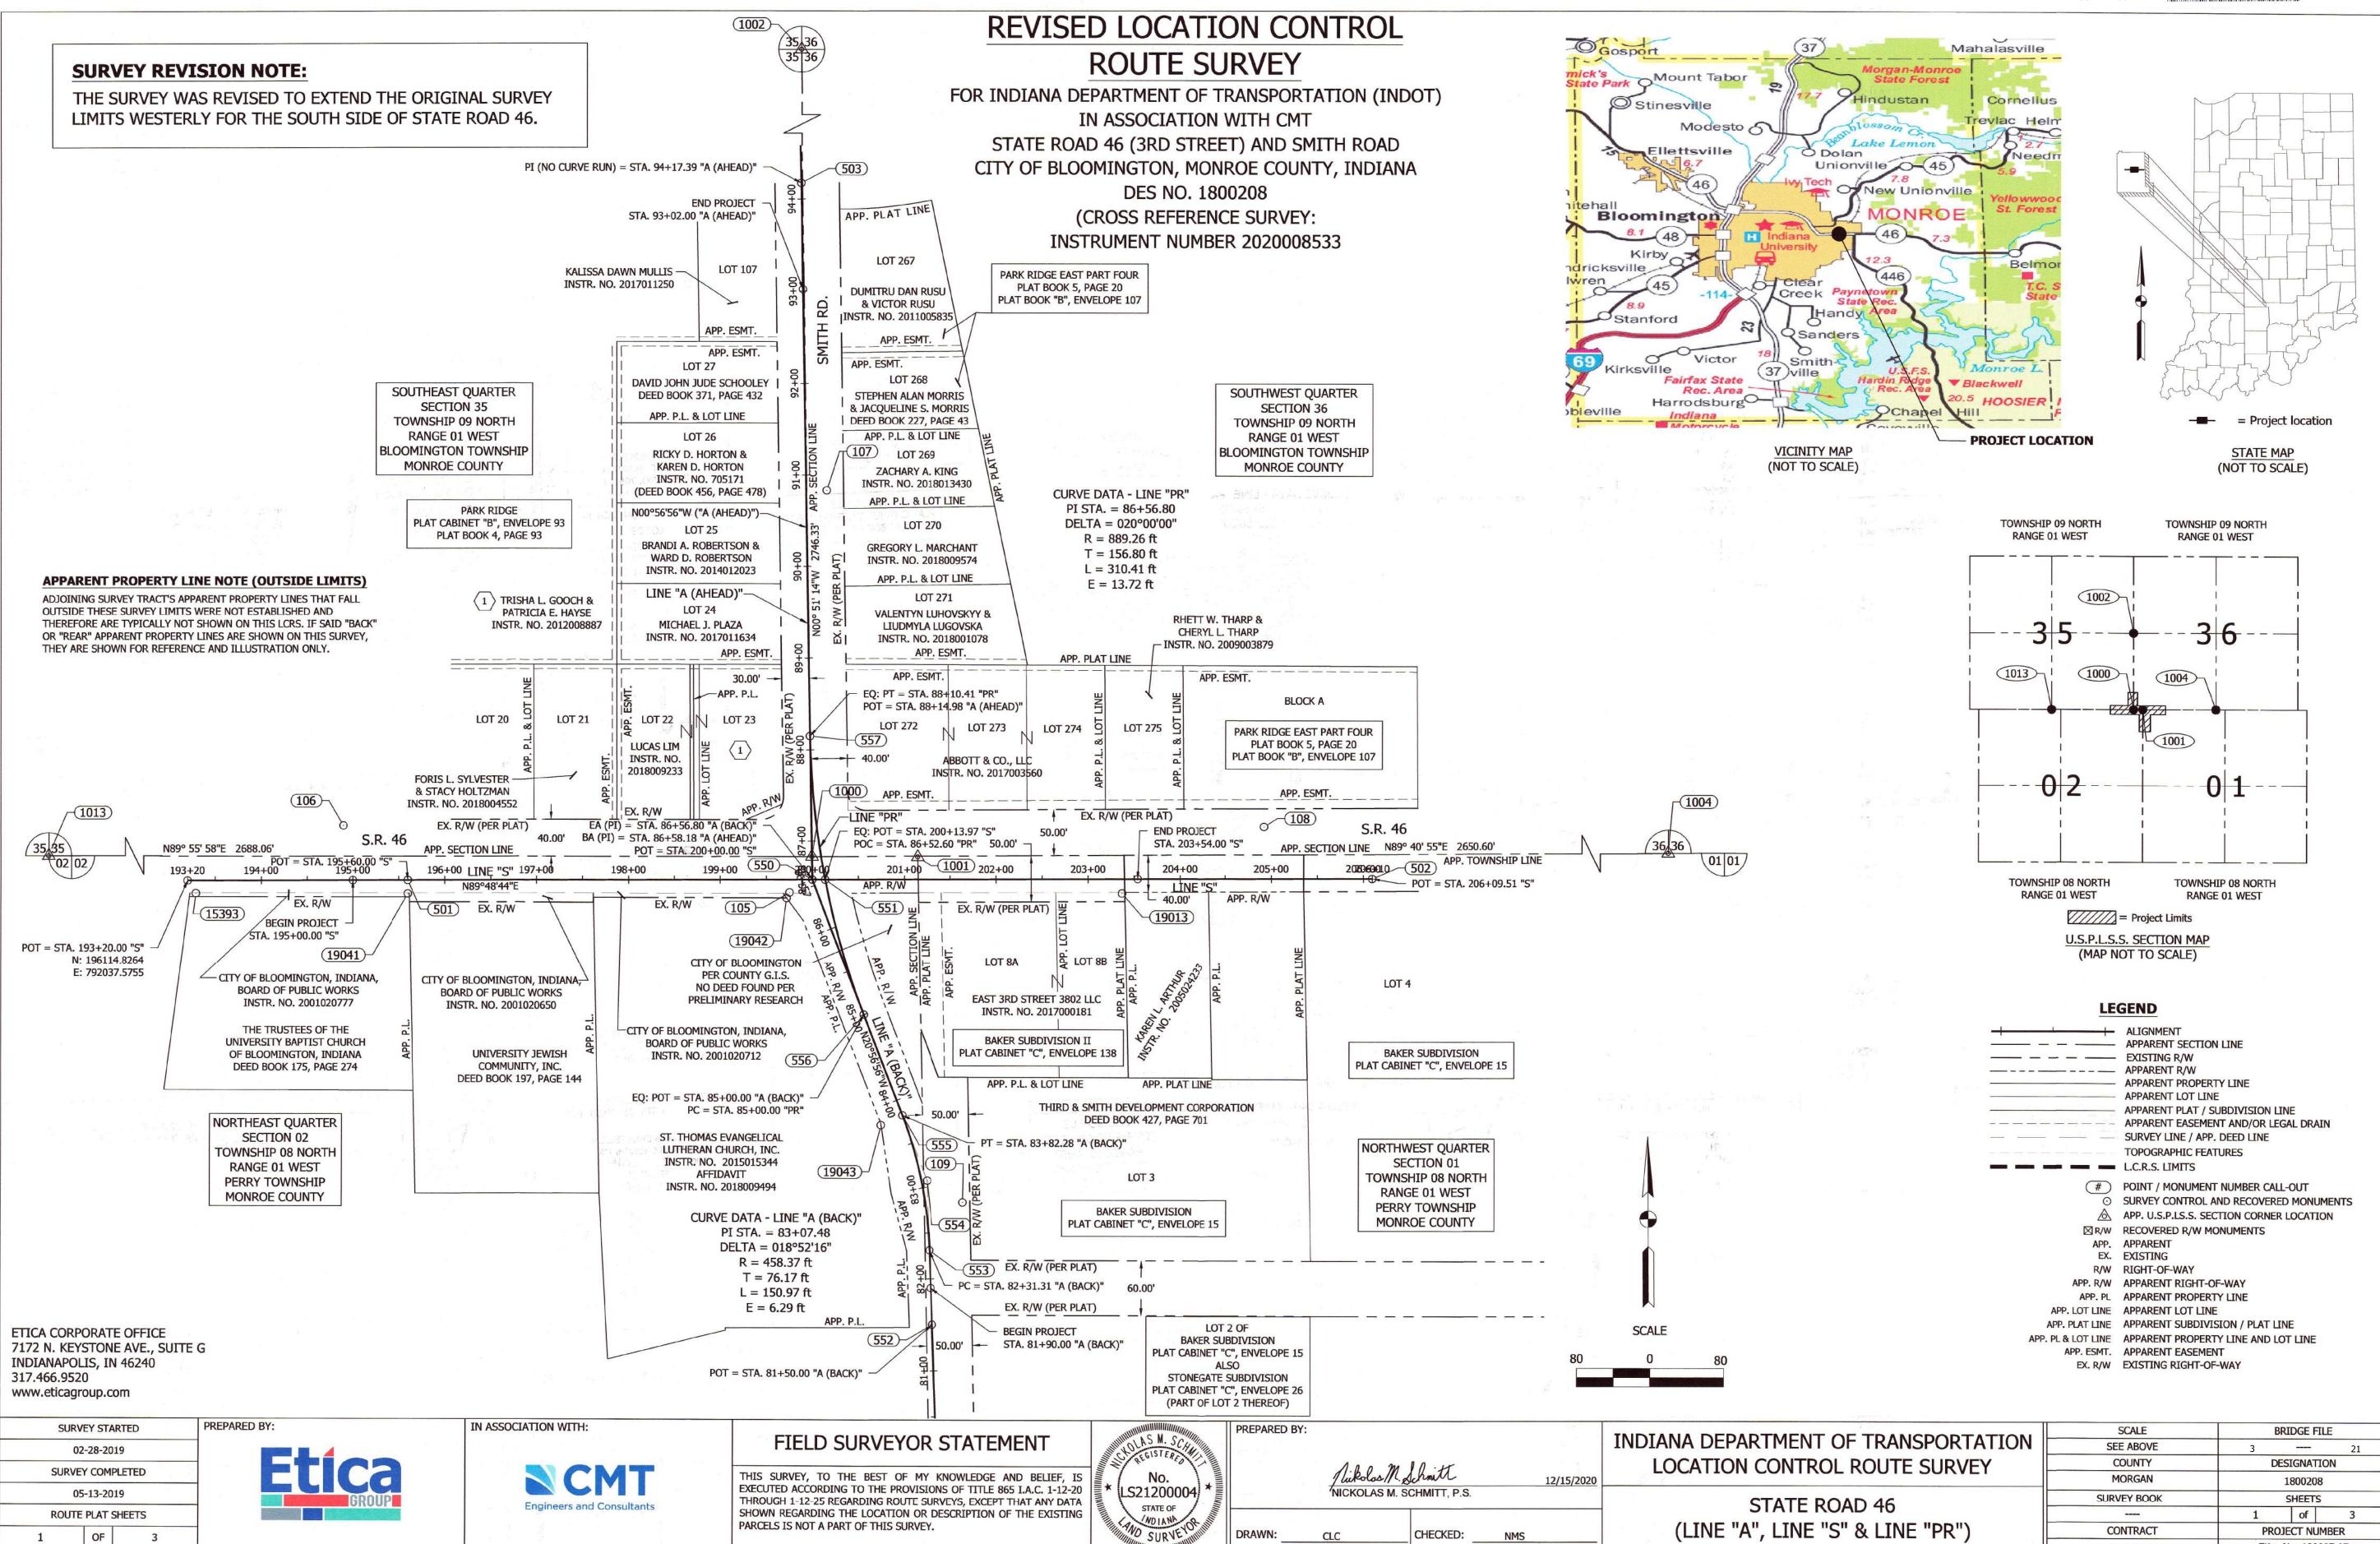

REVISED LOCATION CONTROL **ROUTE SURVEY**

FOR INDIANA DEPARTMENT OF TRANSPORTATION (INDOT) IN ASSOCIATION WITH CMT STATE ROAD 46 (3RD STREET) AND SMITH ROAD CITY OF BLOOMINGTON, MONROE COUNTY, INDIANA DES NO. 1800208

> (CROSS REFERENCE SURVEY: INSTRUMENT NUMBER 2020008533

ETICA GROUP MONUMENT NOTES: ETICA CONTROL CAPS = BLUE CAPS WITH STAMPING: "ETICA GROUP CONTROL FIRM #0121"

ETICA CONTROL WASHERS = WASHERS WITH STAMPING: "ETICA GROUP CONTROL FIRM #0121"

ETICA ALIGNMENT CAPS = RED CAPS WITH STAMPING:

ETICA ALIGNMENT WASHERS = WASHERS WITH STAMPING:


"ETICA GROUP ALIGNMENT FIRM #0121"


"ETICA GROUP ALIGNMENT FIRM #0121"


POINT NO.	STATION	OFFSET	ALIGNMENT
	199+75.21	R 13.98'	LINE "S"
105	86+46.50	L 40.73'	LINE "PR"
	86+52.52	L 28.14'	LINE "A (BACK)"
106	194+89.85	L 59.23'	LINE "S"
107	90+82.88	R 22.44'	LINE "A (AHEAD)"
108	204+92.20	L 56.36'	LINE "S"
109	82+78.44	R 40.41'	LINE "A (BACK)"
501	195+60.00	0.00'	P.O.T. LINE "S"
502	206+09.51	0.00' (PER PLAN) R 0.15' (MEAS)	P.O.T. LINE "S"
503	94+17.39 (PER PLAN) 94+17.35 (MEAS)	0.00'	P.I. (NO CURVE) LINE "A (AHEAD)
	200+00.00	0.00'	P.O.T. LINE "S"
550	86+56.80	0.00'	E.A. (P.I) LINE "A (BACK)"
	86+58.18	0.00'	B.A. (P.I.) LINE "A (AHEAD)"
ee.	200+13.97	0.00'	P.O.T. LINE "S"
551	86+52.60	0.00'	P.O.C. LINE "PR"
552	81+50.00	0.00'	P.O.T. LINE "A (BACK)"
553	82+31.31	0.00'	P.C. LINE "A (BACK)"
554	83+07.48	(P.I. LINE "A (BACK)"
555	83+82.28	0.00'	P.T. LINE "A (BACK)"
FFC	85+00.00	0.00'	P.C. LINE "PR"
556	85+00.00	0.00'	P.O.T. LINE "A (BACK)"
557	88+10.41	0.00'	P.T. LINE "PR"
337	88+14.98	0.00'	P.O.T. LINE "A (AHEAD)"
	199+99.67	L 24.98'	LINE "S"
1000	86+79.54	L 9.72'	LINE "PR"
	86+83.16	0.00'	P.O.T. LINE "A (AHEAD)"
1001	201+14.62	L 24.43'	LINE "S"
1001	86+58.14	R 103.44	LINE "PR"


		The Hornovice of the Control						
	SURVEY POINT METADATA TABLE (SEE SURVEYOR'S REPORT FOR COORDINATE SYSTEM INFORMATION)							
POINT NO.	NORTHING	EASTING	LATITUDE	LONGITUDE	POINT DESCRIPTION	MONUMENT DESCRIPTION		
105	196102.9974	792692.8249	N039°09'50.8519"	W086°28'52.8030"	ETICA SURVEY CONTROL POINT	MAG NAIL WITH ETICA CONTROL WASHER SET FLUSH		
106	196174.6085	792207.2281	N039°09'51.5606"	W086°28'58.9679"	ETICA SURVEY CONTROL POINT	MAG NAIL WITH ETICA CONTROL WASHER SET FLUSH		
107	196542.0701	792732.9783	N039°09'55.1914"	W086°28'52.2921"	ETICA SURVEY CONTROL POINT	MAG NAIL WITH ETICA CONTROL WASHER SET FLUSH		
108	196175.0295	793209.5841	N039°09'51.5627"	W086°28'46.2421"	ETICA SURVEY CONTROL POINT	5/8 IN. DIA. REBAR WITH ETICA CONTROL CAP SET FLUSH		
109	195765.9436	792881.6195	N039°09'47.5202"	W086°28'50.4070"	ETICA SURVEY CONTROL POINT	MAG NAIL WITH ETICA CONTROL WASHER SET FLUSH		
501	196115.6135	792277.5742	N039°09'50.9774"	W086°28'58.0750"	ALIGNMENT MON. RECOVERED - P.O.T. LINE "S"	3/4 IN. DIA. REBAR WITH PCS CAP FLUSH		
502	196118.9015	793327.0846	N039°09'51.0077"	W086°28'44.7505"	ALIGNMENT MON. RECOVERED - P.O.T. LINE "S"	MAG NAIL WITH PCS CONTROL WASHER FLUSH		
503	196876.1216	792704.9938	N039°09'58.4930"	W086°28'52.6465"	ALIGNMENT MON. RECOVERED - P.I. (NO CURVE) LINE "A (AHEAD)"	MAG NAIL WITH PCS CONTROL WASHER FLUSH		
550	196117.0565	792717.5718	N039°09'50.9908"	W086°28'52.4888"	ALIGNMENT POINT - P.I. LINE "PR", E.A. LINE "A (BACK)" & B.A. LINE "A (AHEAD)"	CALCULATED POINT - NO MONUMENT SET DUE TO SAFETY		
551	196117.1023	792731.5395	N039°09'50.9912"	W086°28'52.3115"	ALIGNMENT POINT - P.O.C. LINE "PR" & P.O.T. LINE "S"	CALCULATED POINT - NO MONUMENT SET DUE TO SAFETY		
552	195632.1612	792848.6685	N039°09'46.1981"	W086°28'50.8257"	ALIGNMENT POINT SET - P.O.T. LINE "A (BACK)"	CALC. POINT - MAG NAIL WITH "ETICA ALIGN." WASHER FLUSH		
553	195713.4177	792845.7203	N039°09'47.0012"	W086°28'50.8629"	ALIGNMENT POINT SET - P.C. LINE "A (BACK)"	CALC. POINT - MAG NAIL WITH "ETICA ALIGN." WASHER FLUSH		
554	195789.5425	792842.9584	N039°09'47.7536"	W086°28'50.8978"	ALIGNMENT POINT SET - P.I. LINE "A (BACK)"	CALC. POINT - MAG NAIL WITH "ETICA ALIGN." WASHER FLUSH		
555	195860.6822	792815.7230	N039°09'48.4567"	W086°28'51.2434"	ALIGNMENT POINT SET - P.T. LINE "A (BACK)"	CALC. POINT - MAG NAIL WITH "ETICA ALIGN." WASHER FLUSH		
556	195970.6851	792773.6492	N039°09'49.5440"	W086°28'51.7772"	ALIGNMENT MON RECOVERED - P.O.T. LINE "A (BACK)" & P.C. LINE "PR"	MAG NAIL WITH PCS CONTROL WASHER FLUSH		
557	196273.8582	792714.9904	N039°09'52.5406"	W086°28'52.5212"	ALIGNMENT MON. RECOVERED - P.T. LINE "PR" & P.O.T. LINE "A (AHEAD)"	MAG NAIL WITH PCS CONTROL WASHER FLUSH		
1000	196142.0326	792717.1557	N039°09'51.2376"	W086°28'52.4940"	APPARENT U.S.P.L.S.S. SECTION CORNER MONUMENT RECOVERED	SEE SURVEYOR'S REPORT		
1001	196141.8592	792832.1126	N039°09'51.2357"	W086°28'51.0345"	APPARENT U.S.P.L.S.S. SECTION CORNER MONUMENT RECOVERED	SEE SURVEYOR'S REPORT		
1002	198888.0564	792676.2294	N039°10'18.3780"	W086°28'53.0065"	APPARENT U.S.P.L.S.S. SECTION CORNER MONUMENT RECOVERED	SEE SURVEYOR'S REPORT		
1004	196156.7473	795367.7176	N039°09'51.3763"	W086°28'18.8428"	APPARENT U.S.P.L.S.S. SECTION CORNER MONUMENT RECOVERED	SEE SURVEYOR'S REPORT		
1013	196138.8848	790029.0992	N039°09'51.2106"	W086°29'26.6213"	APPARENT U.S.P.L.S.S. SECTION CORNER MONUMENT RECOVERED	SEE SURVEYOR'S REPORT		


U.S.P.L.S.S. SECTION CORNER REFERENCES

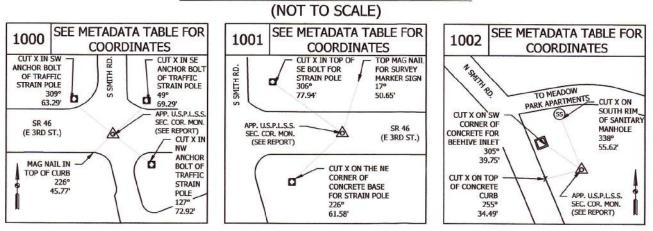

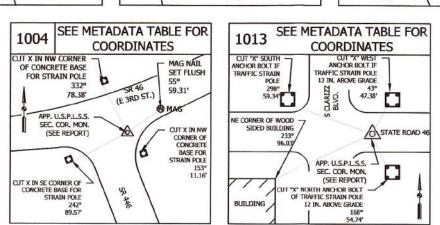


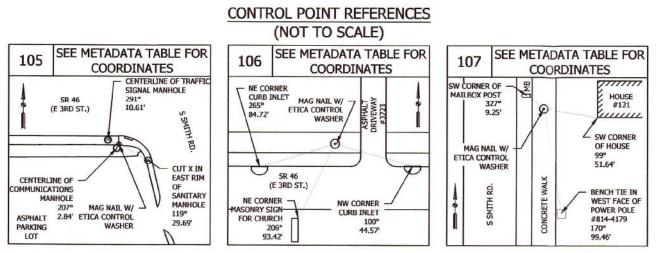


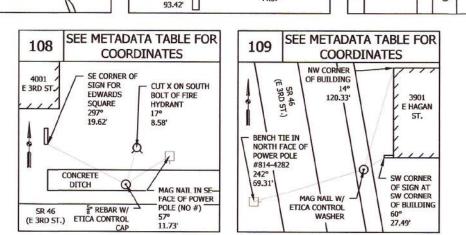

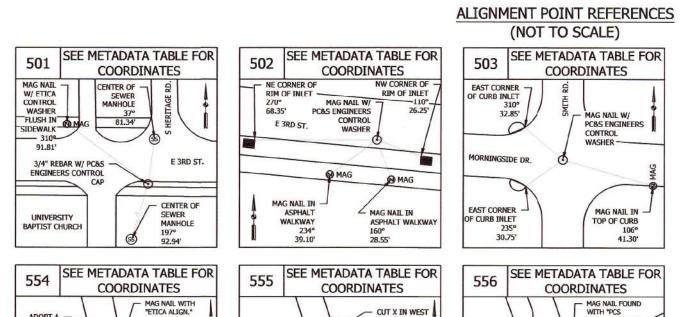



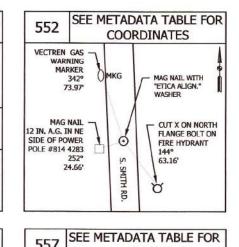

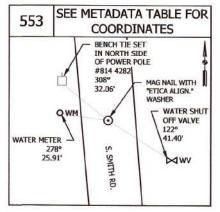

30.	75'	41.30'				
556	7,500	ATA TABLE FOR DINATES	557	SEE I		TA TABLE FOR
ST. TH CH	VOOD 🔪	MAG NAIL FOUND WITH 'PCS ALIGN." WASHER AG. IN WEST SIDE OF POWER POLE 117° 37.22'	NO PARKIN SIC 27: 17:8 BIKE ROU SIC 20 30:0	EN 2º 0' TE 7	O. SMITH RD.	MAG NAIL FOUND WITH "PCS ALIGN." WASHER 30 MPH SIGN 83° 17.23'

(NOT TO SCALE)

COORDINATES

MAG NAIL IN

SURVEY STARTED
02-28-2019
SURVEY COMPLETED
05-13-2019
ROUTE PLAT SHEETS

2

OF



IN ASSOCIATION WITH:



FIELD SURVEYOR STATEMEN					
	ETELL	CLIE	VEVOD	CTA	TEMENT

THIS SURVEY, TO THE BEST OF MY KNOWLEDGE AND BELIEF, IS EXECUTED ACCORDING TO THE PROVISIONS OF TITLE 865 I.A.C. 1-12-20 THROUGH 1-12-25 REGARDING ROUTE SURVEYS, EXCEPT THAT ANY DATA SHOWN REGARDING THE LOCATION OR DESCRIPTION OF THE EXISTING PARCELS IS NOT A PART OF THIS SURVEY.

CA REGISTERED	PREPA
 No.	
STATE OF SURVEY	DRAW

PREPARED BY:		
7	NICKOLAS M. SCHMITT, P.S.	12/15/2020
DRAWN:CL	_C CHECKED:	NMS

— CP 109 -MAG NAIL WITH ETICA CONTROL WASHER 121° 45.29'

BENCH TIE SET ON NORTH SIDE OF POWER POLE #814 4282 202° 60.53'

INDIANA DEPARTMENT OF TRANSPORTATION)[
LOCATION CONTROL ROUTE SURVEY	

META-DATA TABLES AND REFERENCE	ES

		Etica No. 180097.07				
	CONTRACT	PROJECT NUMBER				
		4	of	21		
	SURVEY BOOK		SHEETS			
	MORGAN	1800208				
	COUNTY	DESIGNATION				
	SEE ABOVE					
	SCALE	BRIDGE FILE				

REVISED LOCATION CONTROL **ROUTE SURVEY**

FOR INDIANA DEPARTMENT OF TRANSPORTATION (INDOT)

IN ASSOCIATION WITH CMT

STATE ROAD 46 (3RD STREET) AND SMITH ROAD CITY OF BLOOMINGTON, MONROE COUNTY, INDIANA

DES NO. 1800208

(CROSS REFERENCE SURVEY:

INSTRUMENT NUMBER 2020008533

Surveyors Report:

Etica Group Project Number: 180097.07

General Description and Location:

The Northeast Quarter of Section 2 and Northwest Quarter Sections 1, both in Township 8 North, Range 1 West, Perry Township, and Southeast Quarter of Section 35 and Southwest Quarter of Section 36, both in Township 9 North, Range 1 West, Bloomington Township, all in the City of Bloomington, Monroe County, Indiana.

Field measurements for this survey were made in accordance with specifications outlined in 865 I.A.C. 1-12. The decimal place shown hereon for measurements and coordinates do not necessarily indicate the precision of the work, but to allow for closure and adjustment by others if desired.

Project Control and Basis of Bearings:

InGCS "Monroe" zone:

Unless noted otherwise, all bearings, distances, areas, and coordinates shown hereon are based upon the Indiana Geospatial Coordinate System's (InGCS) "Monroe" zone per NAD 83 (2011) epoch 2010.00 and are reported in U.S. Survey Feet and decimal No other plan or right-of-way transfer documents were received from INDOT. parts thereof. The zone was developed to minimize the differences between ground-measured horizontal distances and the corresponding grid coordinate (map) distances within the counties bearing these zone names.

The InGCS zone coordinates and associated metadata are listed to facilitate a seamless workflow between various geospatial found during this survey.

InGCS "Monroe" Zone Parameters

Geometric Datum: NAD 83(2011) epoch 2010.00

Units: U.S. Survey Feet Projection Type: Transverse Mercator

Central Meridian: 86°30'00" west longitude

Central Meridian scale factor: 1.000028

Latitude of Grid Origin: 38°57'00" north latitude

False Northing: 36,000.000 m (118,110.00 U.S. Ft)

False Easting: 240,000.000 m (787,400.00 U.S. Ft)

The control system parameters used for this survey were provided by INDOT. Etica Group verified the system with an O observation on NGS Monument PID "KA2024" (Des. BLOOMINGTON NCMN 7291).

Published Coordinates Observed Coordinates Delta(Δ) Value + 0.0039Northing: 201,644.0036 Northing: 201,644.0075 Easting: 787,850.5876 Easting: 787,850.6115

The monument was verified utilizing the INDOT Continuously Operating Reference Station (INCORS) a real-time kinematic (RTK) The plat and survey were prepared based upon research of the public records to determine the last deed of record for source of correction service over the internet. This system is stated by INDOT as "Providing Network RTK in RTCM (Real Time Correction title for the subject tract and adjoining properties and is therefore subject to any statements of facts revealed by examination of Message) 2.3, and 3.1 in the MAX (R2K2 Full) and i-MAX (R2K2 LITE) formats via NTRIP (Networked Transport of RTCM via prior deeds or other documents that may exist that would affect this parcel. Internet) and TCP/IP, as well as CMR and CMR+ in the MAX (R2K2 Full) and i-MAX (R2K2 LITE) formats via NTRIP, and TCP/IP."

The purpose of this survey was to provide the client with a Location Control Route Survey (LCRS) plat (as defined in Title 865 of the Indiana Administrative Code as a "Route Survey") using the Indiana Geospatial Coordinate System (InGCS) and provide a corresponding Topographic Survey. This is NOT a boundary survey (as defined in Title 865 as an "original survey" or a "retracement survey"), and should therefore not be treated as such.

The purpose of this survey was to collect survey data for the preparation of design plans for CMT and prepare a corresponding LCRS. This survey is located in the City of Bloomington, Monroe County, Indiana. The limits are along State Road 46 and North Smith Road. The survey limits, centered at the intersection of State Road 46 and North Smith Road, consisted of the following: Southeast Corner of Section 35 (Pt. No. 1000): (1) approx. 600 feet north of the intersection; (2) approx. 500 feet south of the intersection; (3) approx. 300 feet west of the A mag nail with no washer flush with grade was recovered. A three (3) inch road nail is shown as this section corner monument

Referenced Documents, Surveys, and Plans:

All record descriptions, recorded documents, and platted land (plats and subdivisions) were obtained from the Office of the Recorder of Monroe County, Indiana, unless noted otherwise. Resources and referenced documents found or obtained for this survey that were used to help establish the apparent boundary lines, plat lines, survey lines, alignments, and / or right-of-way Northwest Corner of Section 1 (Pt. No. 1001): lines for this survey are as follows:

- Google Earth
- County GIS
- County Surveyors Office Section Corner References (Monument Records)
- Recorded Location Control Route Survey as prepared by Parsons, Cunningham, & Shartle Engineers, Inc. as dated 05-03-2009 and recorded as Instrument Number 2009008898.
- Recorded Boundary and Topographic Survey as prepared by Bledsoe Riggert Guerrettaz, dated 04-23-2007 and recorded as Instrument Number 2007007532

(Please note that this may not be a comprehensive list of all documents researched for or found for this project.)

INDOT Research Request and Documentation:

The Indiana Department of Transportation (INDOT) research request form was submitted (said request included construction plans, right-of-way plans, and grant/deeds) for this survey per INDOT's website on 02/06/2019.

An email from INDOT was received on 02/06/2019 with plan documents attached and are as described as follows:

State Highway Department State Highway Plans for F-Project No. 128 (3).

The above plans were of little help in regards to this project so an additional request was submitted for plans. On 04/12/2019, an email was received with plan documents attached as follows:

• INDOT State Highway Plans for STP-Project No. X380 (Contract No. R-20969).

Etica also during their research located preliminary INDOT Right-of-Way plans for Code 4984, Des. No. 0100773. Per the INDOT research team, this project right-of-way was eliminated in SPMS.

The Etica Group, Inc. is a sub consultant to CMT.

industries (surveying, civil engineering, construction, environmental, GIS, etc.), to provide a means by which to enable the INDIANA ADMINISTRATIVE CODE: In accordance with Title 865, Article 1, Chapter 12 ("Rule 12") of the Indiana Administrative re-establishment of the survey lines, I.e. alignments (should any monuments on them be destroyed), and to provide a Code-State Board of Registration for Land Surveyors, the following observations and opinions are submitted regarding the various mechanism for the perpetuation of any boundary corner monuments included in this survey, e.g., USPLS, Grant, Donations, local uncertainties in the locations of the lines and corners established this survey as a result of uncertainties in the locations of the lines and corners established this survey as a result of uncertainties in the locations of the lines by distances greater or less than the uncertainty cited in this report or shown on the plat of survey. When fences or other subdivisions and/or tracts. To preserve the relative positional relationships of these surveyed lines and/or boundary corner monumentation (both availability and condition); in lines of occupation are shown on the plat, they have been located only at the ends or specific locations noted; therefore, for the lines of occupation are shown on the plat, they have been located only at the ends or specific locations noted; therefore, for the lines of occupation are shown on the plat, they have been located only at the ends or specific locations noted; therefore, for the lines of occupation are shown on the plat, they have been located only at the ends or specific locations noted; therefore, for the lines of occupation are shown on the plat, they have been located only at the ends or specific locations noted; therefore, for the lines of occupation are shown on the plat, they have been located only at the ends or specific locations noted; therefore, for the lines of occupation are shown on the plat, they have been located only at the ends or specific locations noted; therefore, for the lines of occupation are shown on the plat, they have been located only at the ends or specific locations noted; therefore, for the lines of occupation are shown on the plat, they have been located only at the ends or specific locations noted; therefore, for the lines of occupation are shown on the plat, they have been located only at the ends or specific locations noted; therefore, for the located only at the ends or specific locations noted; therefore, for the located only at the ends or specific locations noted; therefore, for the located only at the ends or specific locations noted; therefore, for the located only at the ends or specific locations noted; therefore, for the located only at the ends or specific locations noted; therefore, for the located only at the ends or specific locations noted; therefore, for the located only at the ends or specific locations noted; the ends or specific locations noted; the ends or specific location monuments in future surveying, construction, maintenance, etc. activities, it is recommended to utilize the positions associated introduced by random errors in measurement ("Relative Positional Accuracy"). THERE MAY BE UNWRITTEN RIGHTS ASSOCIATED with the physical "Survey Network Control Points" listed in the "Reported Project Points Metadata Table" that were set and/or straight line. equal in magnitude to the discrepancy in the location of the lines of occupation or possession from the surveyed lines and

> Existing monuments recovered and discussed within this report (said points depicted on the plat pages, alignment, and control references and in the coordinate table) represent true and accurate locations as depicted, corresponding with distances and/or azimuths/bearings (if referenced). All control points set were referenced in accordance to Indiana Department of Transportation Design Manual for Location Surveys Part III. Other points recovered but not shown, may be close, but were not within the estimated uncertainty nor did they have any impact on the establishment of lines as shown herein. Secondary control points may have been set for the use in locating or validating other evidence when establishing rights of way or apparent property/boundary

When fences or other lines of occupation are shown on the plat, they have been located only at the ends or specific locations noted; therefore, for the purpose of this survey, such lines are assumed to run straight between said locations, but in actuality

Any depiction of possible intrusion, trespass, invasion, and/or possible encroachment into the possessions or rights of another is may vary slightly from such straight line.

Since the date of this survey, conditions may have occurred that are beyond the knowledge or control of the undersigned surveyor that may have altered the validity and circumstances shown or noted herein. The location of the survey lines and Observations and Opinions - Availability and Condition of Reference Monuments: surveyor may alter the location of said lines and corners.

As used in this survey, the term "certify" means to state or declare a professional opinion of conditions regarding those facts or findings which are the subject of the certification and does not constitute a warranty or guarantee, either expressed or implied. The surveyor can only certify to those items that are visible and/or things that can be observed, measured, or counted.

U.S. Public Land Survey System (USPLSS) Section Line Determination and Recovered Monuments The recovery of apparent section corner monuments for Section 1 and Section 2, Township 8 North, Range 1 West, and Section 35 and Section 36, Township 09 North, Range 01 West, worthy of mention are as follows:

intersection; and (4) approx. 350 feet east of the intersection. The width of the survey corridor varies along the roadway corridor. per the Monroe County Surveyor's Monument Record. The reference ties per said Monument Record were verified in the field against this recovered mag nail monument. It was determined that this was the best available evidence of the section corner location and said recovered monument was held as such. There is considered to be an unknown amount of uncertainty associated with this corner.

A road nail one (1) inch below grade was recovered. A railroad spike is shown as this section corner monument per the Monroe County Surveyor's Monument Record, the recorded location control route survey as recorded in Instrument Number 2009008898, and per other recorded surveys. Two references per the County Surveyor's Monument Record were verified against the road nail recovered. It was determined that this was the best available evidence of the section corner location and said recovered monument was held as such. There is considered to be up to 1.0 foot of uncertainty associated with this corner.

East Quarter Corner of Section 35 (Pt. No. 1002):

A 1.25 inch diameter boat spike three (3) inches below grade was recovered per the Monroe County Surveyor's Monument Record. There is considered to be no uncertainty associated with this corner.

South Quarter Corner of Section 36 (Pt. No. 1004):

A one (1) inch diameter pin in six (6) inch concrete sleeve flush with grade was recovered. A railroad spike is shown as this section corner monument per the Monroe County Surveyor's Monument Record, the recorded location control route survey as recorded as Instrument Number 2009008898, and per other recorded surveys. Two references per the County Surveyor's Monument Record were verified against the pin recovered. It was determined that this was the best available evidence of the section corner location and said recovered monument was held as such. There is considered to be up to 1.0 foot of uncertainty associated with this corner.

U.S. Public Land Survey System (USPLSS) Section Line Determination and Recovered Monuments (Cont.)

South Quarter Corner of Section 35 (Pt. No. 1013):

A mag nail with no washer flush with grade was recovered. No Monroe County Surveyor's Monument Record was found in Line "A (BACK)" and Line "A (AHED)" correspond to Line "A" as described in the Recorded Location Control Route Survey as section corner location and said recovered monument was held as such. There is considered to be an unknown amount of Contract No. R-20969 (hereon referred to as Highway Plans). uncertainty associated with this corner.

West Line of the Northwest Quarter of Section 1 - Calculated Location:

This section line location was calculated per the recorded location control route survey as recorded in Instrument Number The geometric data as described and labeled on the Route Survey and Highway Plans were held to create the alignment into this survey's coordinate system / basis of bearings. This correlation, and therefore section line location, was established Line "A" to Line "S" were held to equate all alignments together. based on holding the angular and distance relationships between the corresponding section corner monuments found for both this survey and the Route Survey.

Apparent Boundary Lines / Lines of Possession / Right of Way Notes:

The recorded last deed of record descriptions of nearby tracts located within the survey limits, recorded subdivision plats, and An alignment monument (Point Number 503) was recovered in regards to Line "A" and alignment monuments (Point Numbers supplemental documents (as listed on the LCRS) were used to establish the apparent boundary lines and right-of-way lines.

Regarding "lines of occupation or possession" in the above section, this term refers to lines which are marked by visible, obvious, well-defined and maintained, man-made or placed objects or limits, such as, but not limited to fences, hedges, mow lines, field-divide lines, woods lines, retaining walls, etc. The uncertainty cited for a line of occupation is general in nature and in not Line "PR" intended to be specific for every point along the line. Therefore, portions of the occupation lines may vary from the surveyed Line "PR" corresponds to Line "PR" as described in the Recorded Location Control Route Survey as prepared by Parsons, purpose of this survey, such lines are assumed to run straight between said locations, but in actuality may vary slightly from such referred to as Highway Plans).

to change based on verification/validation of title. This information is shown only to help orient the user of this plat as it relates to "A (AHEAD)", and Line "S" were held to correlate Line "PR" into this survey's coordinate system / basis of bearings. project centerlines and is not intended to establish existing right of way lines or ownership lines. The source used to plot existing right of way lines and ownership lines shown on this plat is from the last/current deeds of record obtained from the appropriate

Existing Right-of-Way: County Recorder's Office or other state agencies when the research was performed, as well as from other sources cited on this plat. Where no record right of way could be found, the edge of pavement shown may possibly act as an easement by prescription. The designer/consultant responsible for Right of Way Engineering is to complete the final determination of this information. It is always presumed that there are rights associated to all areas where right of way monuments or possession exist; however, documentation is not always provided to show the extent of those rights. No title search or encumbrance report

not a matter of this survey. An attorney and/or title company should be consulted in all matters with respect to any rights of possession, matters of title, and all things with respect to any encumbrances if depicted on this survey.

corners are subject to the evidence found in the performance of this survey. Additional evidence presented to the undersigned The following is a discussion on what monuments were recovered and/or not found in relation to establishing the apparent boundary lines of the subject tracts, deed lines, roadway centerlines and alignments, apparent plat lines, and existing right-of-way (if any), hereon referred to as "survey lines". The number and/or letter associated with each monument represents their monument I.D. as depicted on the survey plat.

- A 5/8 inch diameter rebar with "PCS" cap flush with grade was recovered. This monument was held as the P.O.T station 195+60.00 for Line "S".
- A mag nail with "PCS" washer flush with grade was recovered. This monument was held as the P.O.T. station 206+09.51 for Line "S".
- A mag nail with "PCS" washer flush with grade was recovered. This monument was held as the P.I. (no curve run)

 Easement Note / Disclaimer:
- station 94+17.39 for Line "A (AHEAD)". A mag nail with "PCS" washer flush with grade was recovered. This monument was held as the P.O.T. station 85+00.00
- for Line "A (BACK)". A mag nail with "PCS" washer flush with grade was recovered. This monument was held as the P.O.T. station 88+14.98 for Line "A (AHEAD)".
- 15393. A 5/8 inch diameter rebar with an illegible yellow cap eight (8) inches below grade was recovered and found to be 0.19
- feet south of the south right-of-way line of 3rd Street/S.R. 46.
- A 5/8 inch diameter rebar with cap stamped "SNA LS930019" was recovered and found to be 3.18 feet southwest of an apparent plat corner.
- A 5/8 inch diameter rebar with cap stamped "BRG PC50920004" flush with grade was recovered and found to be 1.76 feet southwest of an apparent property corner. 19042. A 5/8 inch diameter rebar with cap stamped "BRG PC50920004" one (1) inch below grade was recovered and held to
- establish the apparent right-of-way corner. 19043. A 5/8 inch diameter rebar with cap stamped "BRG PC50920004" flush with grade was recovered and found to be 1.89
- feet south of an apparent property corner / apparent right-of-way corner. Bearing and/or distance relationships to recovered monuments on the adjoining properties, roadways, or as located outside the

survey limits are shown on this survey for the purpose of establishing a history of monumentation and to assist in establishing the "survey lines" as located within the survey limits or subject tracts only. This survey does not represent a survey of any type of said adjoining properties, roadways, or corridors.

Line "A (BACK)", Line "A (AHEAD)", & Line "S"

regards to this section corner location. A mag nail found flush was recovered and held as this section corner location per the prepared by Parsons, Cunningham, & Shartle Engineers, Inc. as dated 05-03-2009 and recorded in Instrument Number Recorded USI Consultants, Inc. LCRS (Instr. No. 2008016413). It was determined that this was the best available evidence of the 2009008898 (hereon referred to as Route Survey) and corresponding INDOT State Highway Plans for STP-Project No. X380,

Line "S" corresponds to Line "S" as described per the same Route Survey and Highway Plans.

2009008898 (hereon referred to as Route Survey). This section line location as determined by the Route Survey was correlated configuration and stationing for Line "A (BACK)", "A (AHEAD)", and Line "S". Station equations and angular relationships relating

Five (5) alignment monuments were recovered per the Route Survey and are described in the "Observations and Opinions -Availability and Condition of Reference Monuments" Section of this report.

501 and 502) were recovered for Line "S" as set per the Route Survey. A best fit between these three recovered alignment monuments and the corresponding alignment geometric points was implemented to establish and correlate these alignments into this survey's coordinate system / basis of bearings.

The geometric data as described and labeled on the Route Survey and Highway Plans were held to create the alignment The existing right of way lines, parcel ownership lines, and ownership information shown on this plat are preliminary and subject configuration and stationing for Line "PR". Station equations and angular relationships relating Line "PR" to Line "A (BACK)", Line

Most of the right-of-way as located within the survey limits is considered "existing". The existing right-of-way was established based on recorded subdivision plats (secondary plats), or recorded dedication documents and warranty deeds (transfer of title documents) for right-of-way as labeled and denoted on the attached LCRS plat. The right-of-way as described by the above mentioned documents were established based on their metes and bounds descriptions and platted land depictions.

The right-of-way as located at the Southwest Quadrant of this survey intersection along Smith Road (West side) is considered "apparent". Apparent right-of-way is right-of-way established by documents that may not be formal or legal in regards to the transfer of land or title, or established by field observed evidence distinguishing use and rights of the pubic way. The apparent right-of-way as shown on this LCRS was determined based upon:

 Deed of record (Instrument Number 2015015344 & 2018009494) located within the survey limits with the land descriptions property line describing along the apparent adjacent right-of-way line (though no additional document were found formally dedicating said adjoining right-of-way).

Right-of-Way Note:

Il "apparent" right-of-way as shown on this LCRS is apparent and skeptical in nature. Please note that right-of-way documents may be found per a Title and Encumbrance Report (T&E Report) as prepared for these survey limits, but no such T&E Reports were supplied for this LCRS. Direction will be needed by the client/owner on how to proceed with right-of-way engineering at the next phase of the project.

Locations of any easements shown are based on the last/current deeds of record or recorded plats as obtained from the appropriate County Recorder's Office when the research was performed, as well as from other sources cited on this plat, and should not be interpreted that all possible easements have been recovered as a result of an exhaustive title search. This LCRS was prepared without benefit of current evidence of source of title (Title Work or Encumbrance Report not performed) for the survey area and therefore subject to any statement of facts revealed by examination of such documents. Easements, legal drains, covenants, right-of-way, etc. shown heron does not constitute all encumbrances upon these surveyed tracts.

Certificate of Survey:

This survey, to the best of my knowledge and belief, is executed per the provision of Title 865 I.A.C. 1-12-20 through 1-12-25 regarding route surveys, except that any data shown regarding the location or description of the existing parcels is not a part of this survey. Data and information was collected from 02/28/2019 to 05/13/2019. The data collected was gathering using electronic total stations applying standard radial surveying techniques and by global positioning equipment, utilizing the INDOT Continuously Operating Reference Station (INCORS).

The Relative Positional Accuracy (due to random errors in measurement) of the corners and monuments found and set established during this survey is within the specification for an Urban Survey: 0.07 feet (21 millimeters) plus 50 parts per million (ppm) as defined in I.A.C. 865.

Affirmation Statement:

I affirm, under the penalties of perjury, that I have taken reasonable care to redact each Social Security Number in this document, unless required by law.

Printed Name: NICKOLAS M. SCHMITT

Sl	JRVEY START	ED
	02-28-2019	
SUF	RVEY COMPLE	TED
	05-13-2019	
ROL	JTE PLAT SHE	ETS
3	OF	3




IN ASSOCIATION WITH:



FIELD SURVEYOR STATEMENT

THIS SURVEY, TO THE BEST OF MY KNOWLEDGE AND BELIEF, IS EXECUTED ACCORDING TO THE PROVISIONS OF TITLE 865 I.A.C. 1-12-20 THROUGH 1-12-25 REGARDING ROUTE SURVEYS, EXCEPT THAT ANY DATA SHOWN REGARDING THE LOCATION OR DESCRIPTION OF THE EXISTING PARCELS IS NOT A PART OF THIS SURVEY.

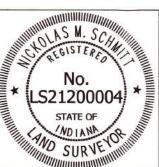

PREPARED BY:


Mikolos M. Schmitt NICKOLAS M. SCHMITT, P.S.	12/15/2020
'NICKOLAS M. SCHMITT, P.S.	

CHECKED:

INDIANA DEPARTMENT OF TRANSPORTATION LOCATION CONTROL ROUTE SURVEY

EOG/111011 CONTINUE ROOTE CONTE	MORGAN	
	SURVEY BOOK	
SURVEYOR'S REPORT AND CERTIFICATION		5
SURVETUR'S REPORT AND CERTIFICATION	CONTRACT	P
	NAME OF THE	FI

	SCALE	В	RIDGE FILI	E		
	SEE ABOVE					
	COUNTY	DESIGNATION				
	MORGAN	1800208				
	SURVEY BOOK		SHEETS			
	CONTRACT OF THE PARTY OF THE PA	5	of	21		
	CONTRACT	PRO	JECT NUM	BER		
		Etica	No. 18009	7.07		

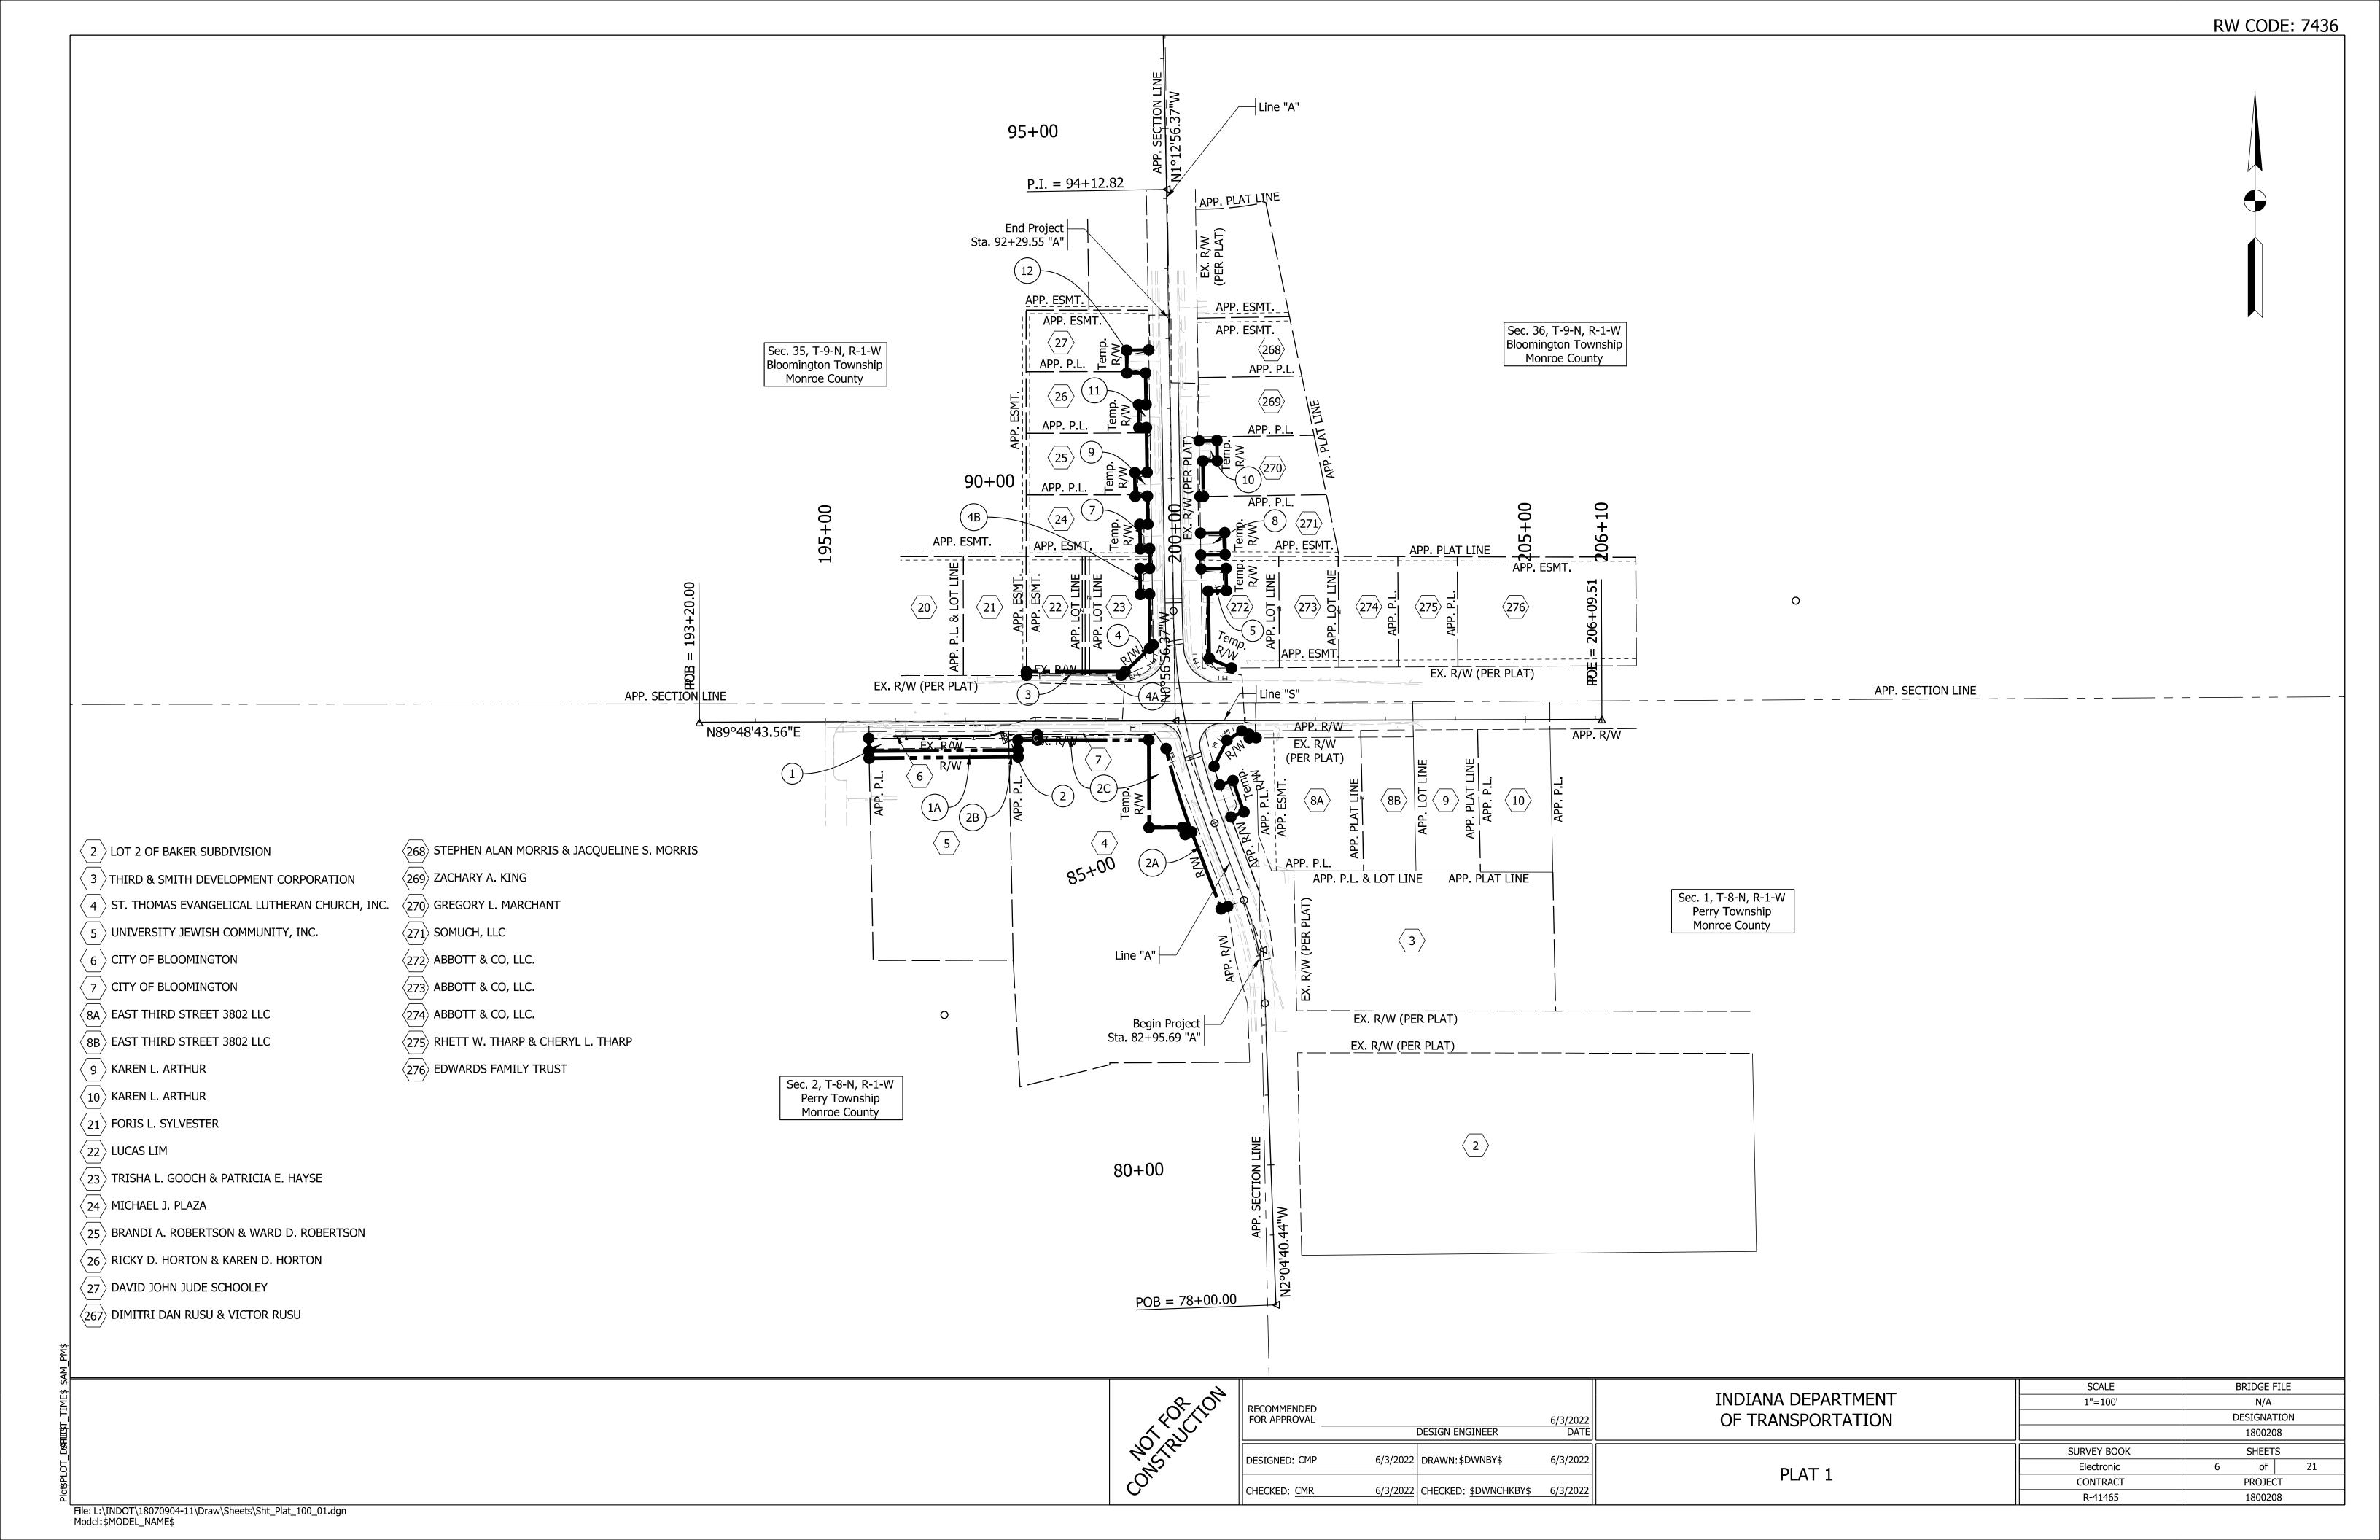

SHEETS

PROJECT


1800208

SURVEY BOOK

Electronic

CONTRACT

R-41465

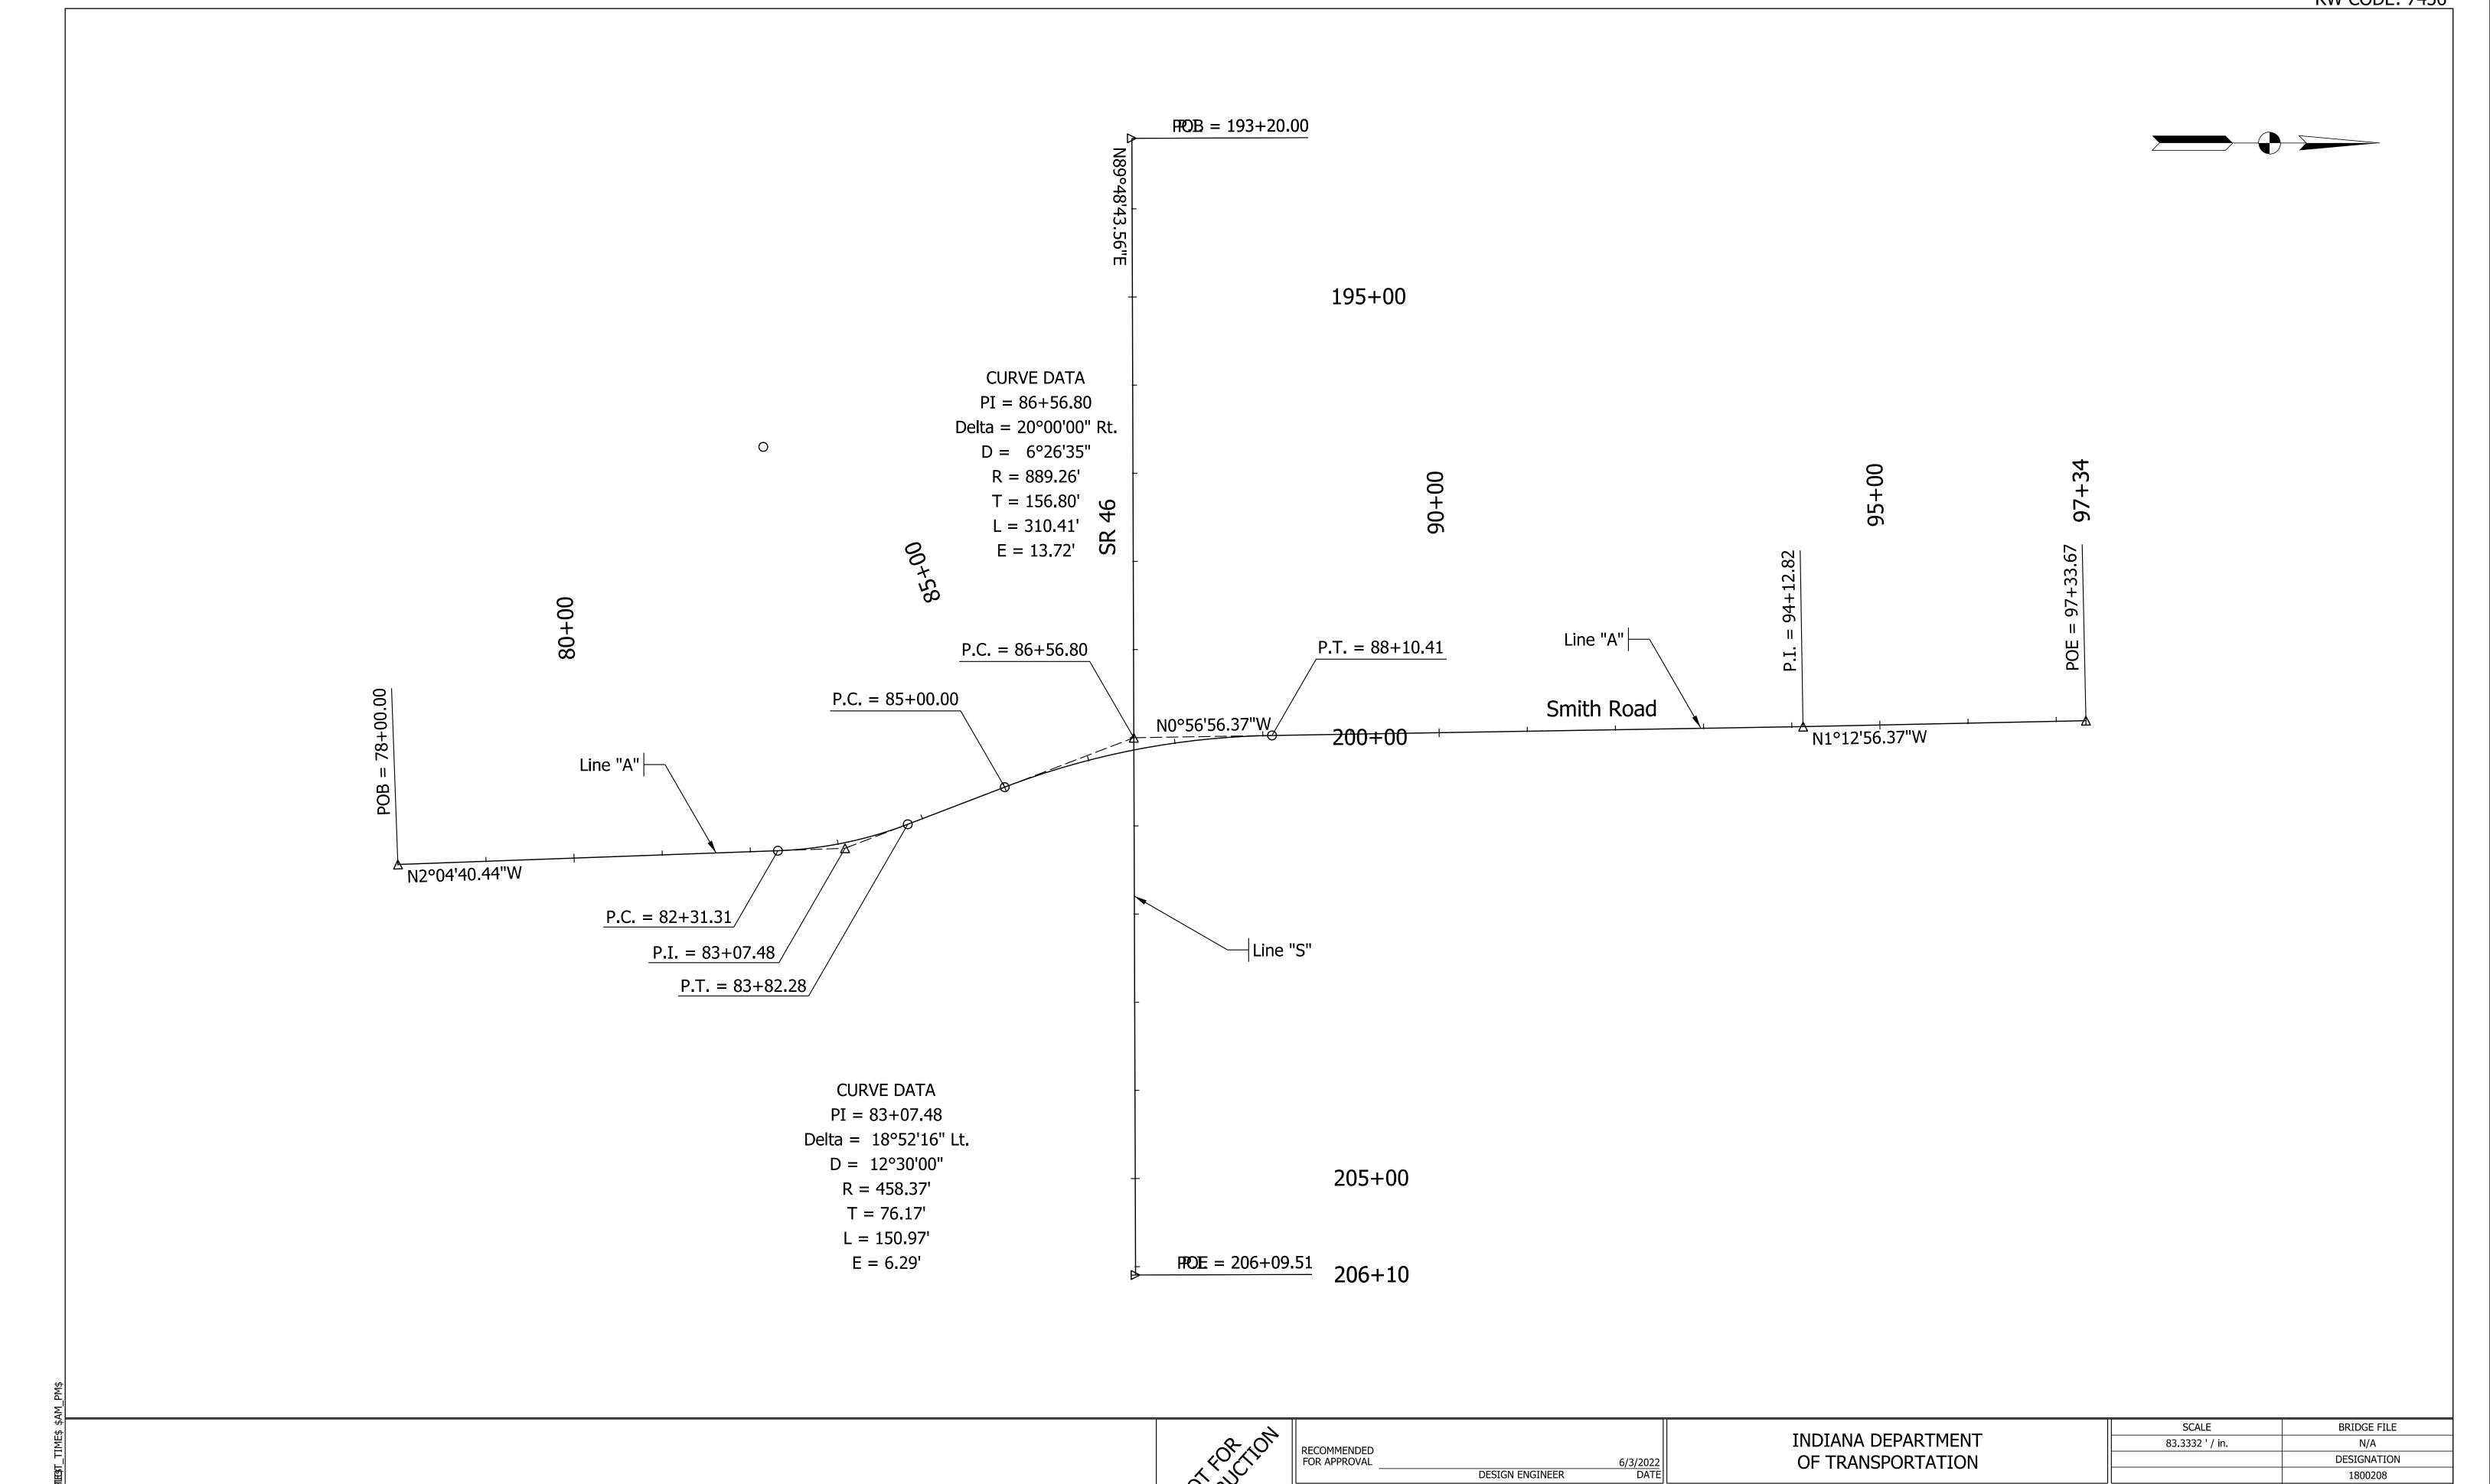

DESIGNED: CMP

CHECKED: CMR

6/3/2022


ALIGNMENT INFORMATION SHEET


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 RECOMMENDED FOR APPROVAL
 6/3/2022

 DESIGN ENGINEER
 DATE

 DESIGNED: CMP
 6/3/2022
 DRAWN: \$DWNBY\$
 6/3/2022

 CHECKED: CMR
 6/3/2022
 CHECKED: \$DWNCHKBY\$
 6/3/2022

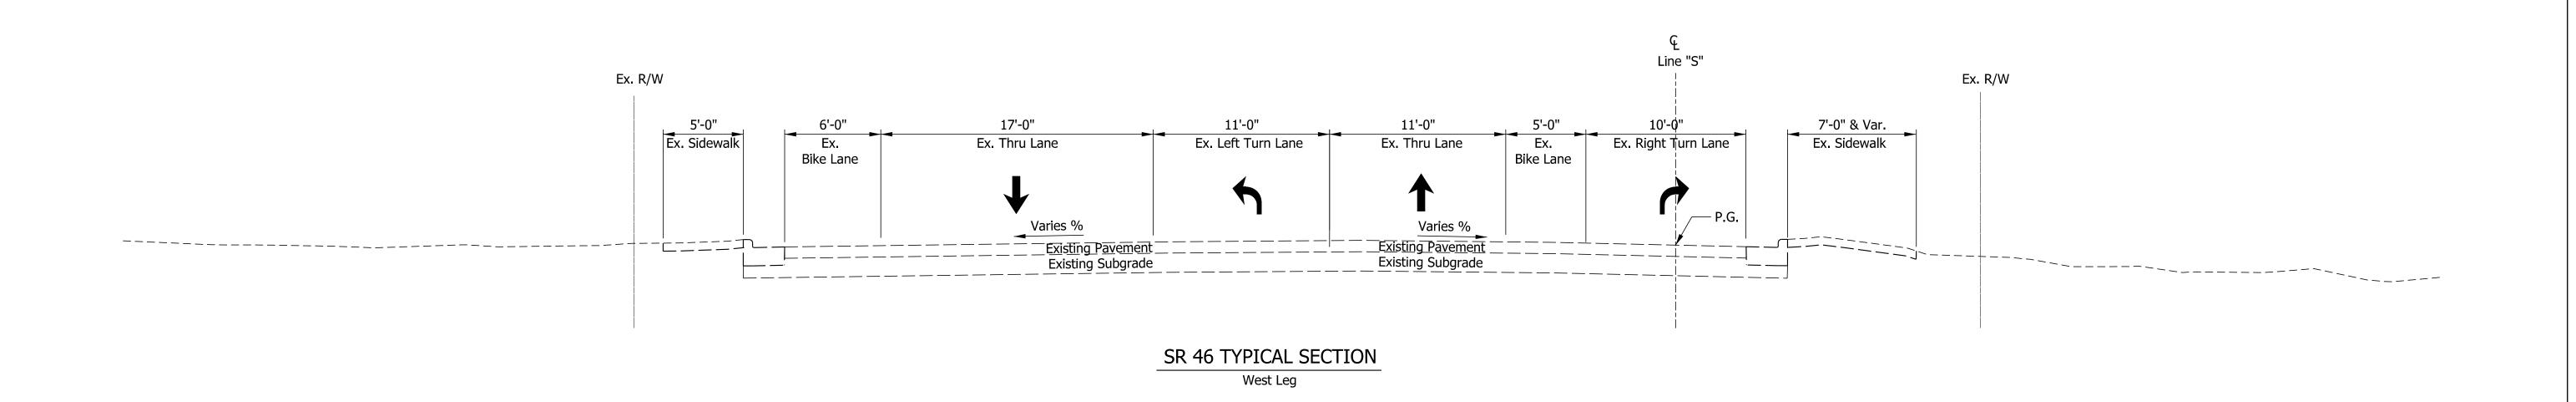INDIANA DEPARTMENT
OF TRANSPORTATION

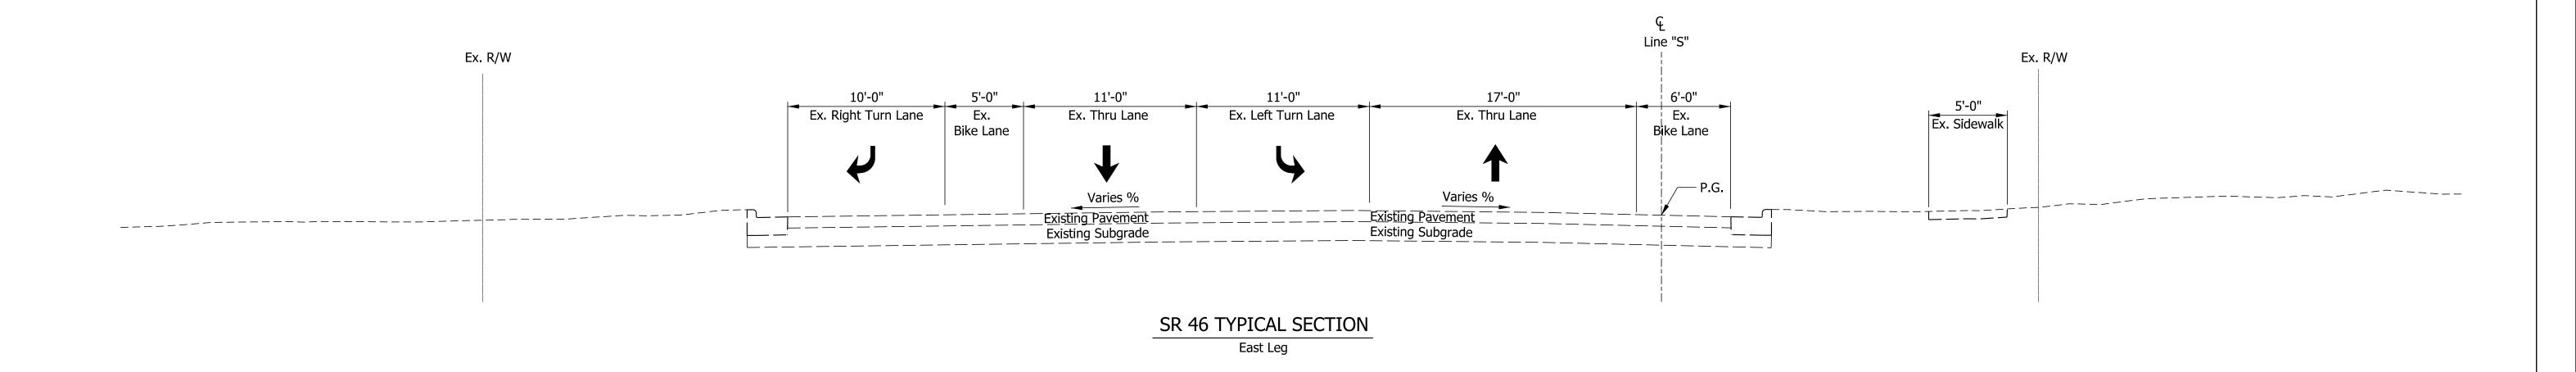EXISTING TYPICAL SECTIONS

LINE "S"

 SCALE
 BRIDGE FILE

 5.0000 ' / in.
 N/A

 DESIGNATION

 1800208

 SURVEY BOOK
 SHEETS


 Electronic
 8 of 21


 CONTRACT
 PROJECT

1800208

R-41465

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RECOMMENDED FOR APPROVAL 6/3/2022 DATE DESIGN ENGINEER 6/3/2022 DRAWN: \$DWNBY\$ 6/3/2022 DESIGNED: CMP CHECKED: CMR 6/3/2022 CHECKED: \$DWNCHKBY\$ 6/3/2022

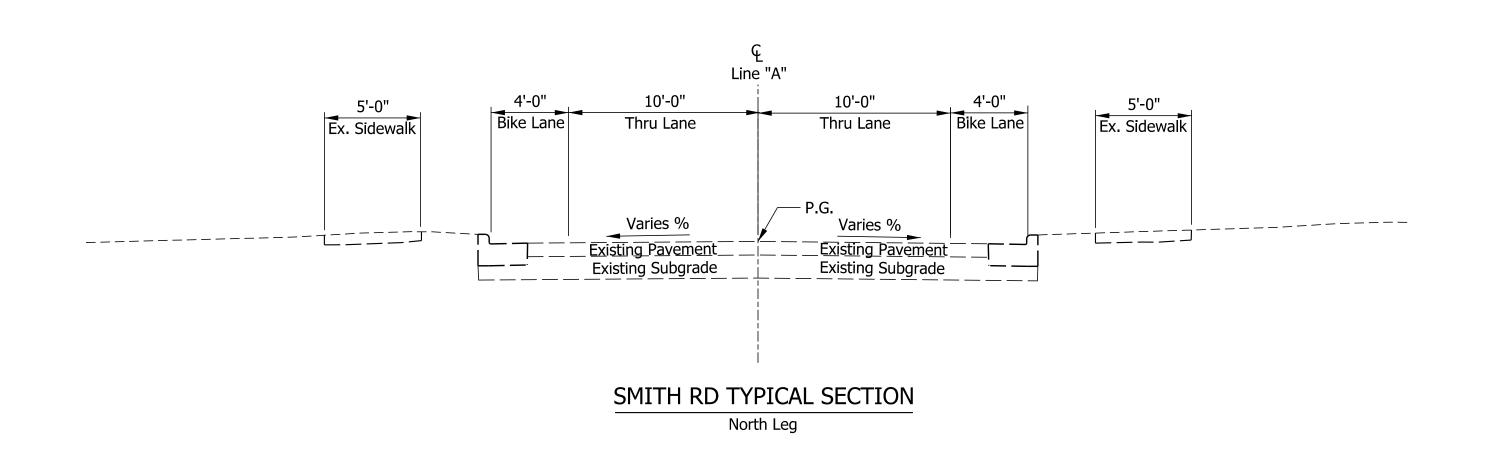INDIANA DEPARTMENT OF TRANSPORTATION EXISTING TYPICAL SECTIONS

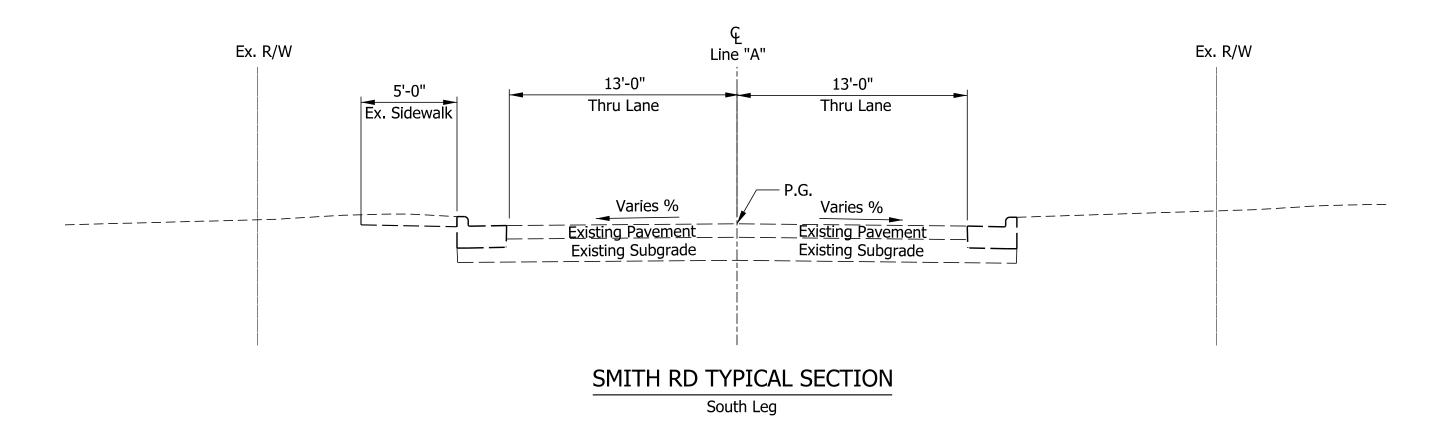LINE "A"

SCALE BRIDGE FILE 5.0000 ' / in. N/A DESIGNATION 1800208 SURVEY BOOK SHEETS of Electronic PROJECT

1800208

CONTRACT


R-41465

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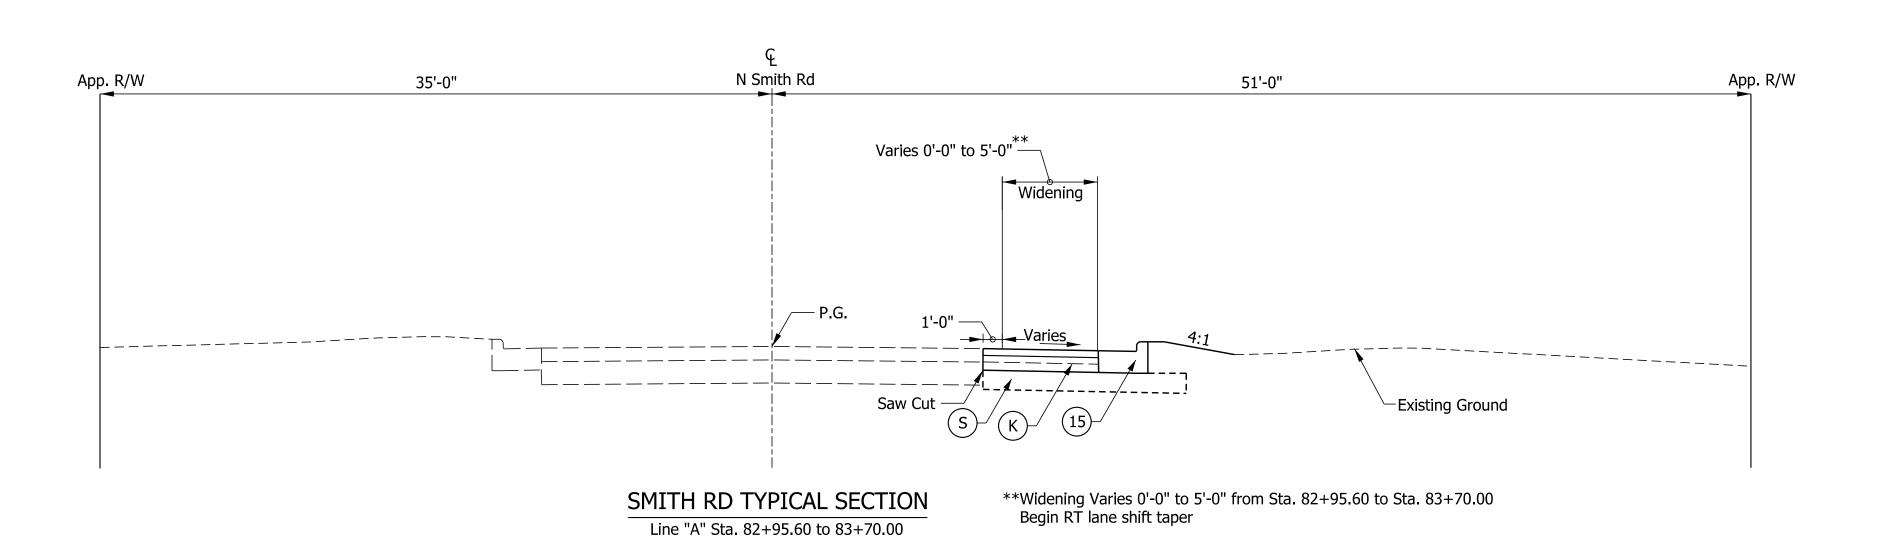
1800208

Note to Reviewer

Pavement Design to be determined by INDOT after Stage 2 Submittal.

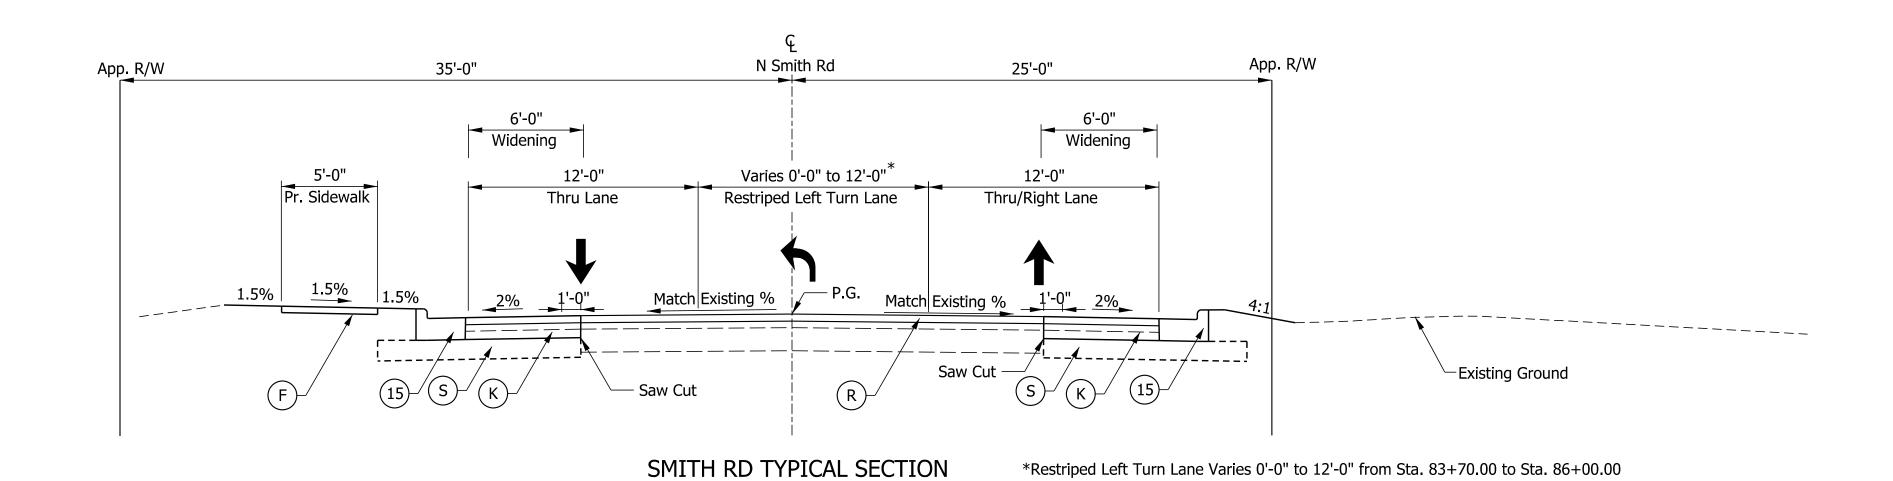

Line "A" Sta. 83+70.00 to 86+00.00



LEGEND

- (K) FULL DEPTH HMA COMPOSED OF: 165 lb/syd QC/QA - HMA, 3, 70, SURFACE, 12.5 mm 440 lb/syd QC/QA - HMA, 3, 70, INTERMEDIATE, 12.5 mm 440 lb/syd QC/QA - HMA, 3, 70, BASE, 25.0 mm
- R MILL AND OVERLAY, 1.5" COMPOSED OF:: 165 lb/syd QC/QA HMA, 3, 70, SURFACE, 12.5 mm
- S SUBGRADE TREATMENT, TYPE IC
- O COMPACTED AGGREGATE, NO. 53
- (15) CURB AND GUTTER, CONCRETE, MODIFIED
- (F) SIDEWALK, CONCRETE
- 26) SODDING

RECOMMENDED FOR APPROVAL 6/3/2022				SCALE	BRI	DGE FILE		
			INDIANA DEPARTMENT	1/2"=1'		N/A		
		6/3/2022	OF TRANSPORTATION		DES	IGNATION	1	
DESIGN ENGINEER DATE			1	800208				
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C (2 (2002)	LINE "A"	12 (2022) GUEGKED + DAVAGUKDY+	CONTRACT	PI	ROJECT			
CHECKED: CMR 6/3/2022 CHE		CHECKED: <u>\$DWNCHKBY\$</u>	6/3/2022		R-41465	13	800208	

***Pavement cross slope to match existing SE slope through limits of SE

BRIDGE FILE

N/A

DESIGNATION

1800208

SHEETS


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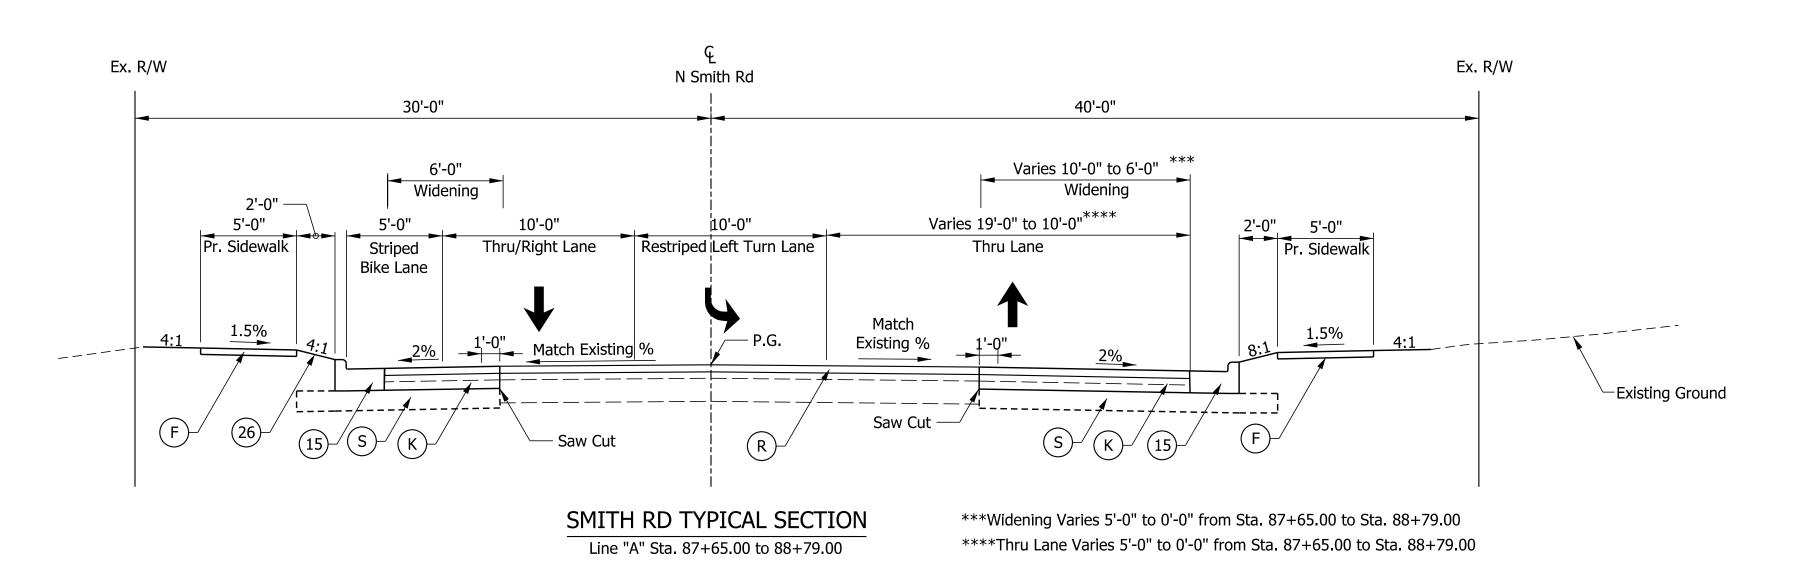
PROJECT

1800208

Note to Reviewer

Pavement Design to be determined by INDOT after Stage 2 Submittal.



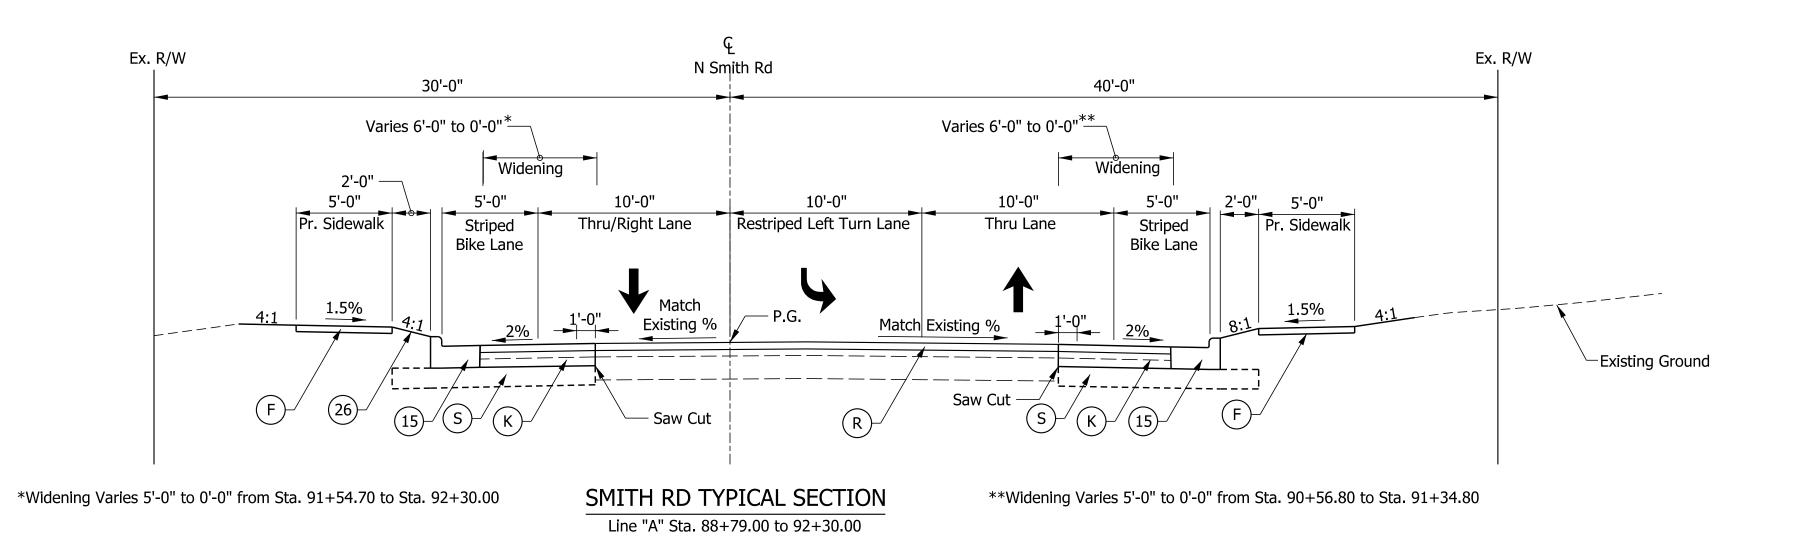


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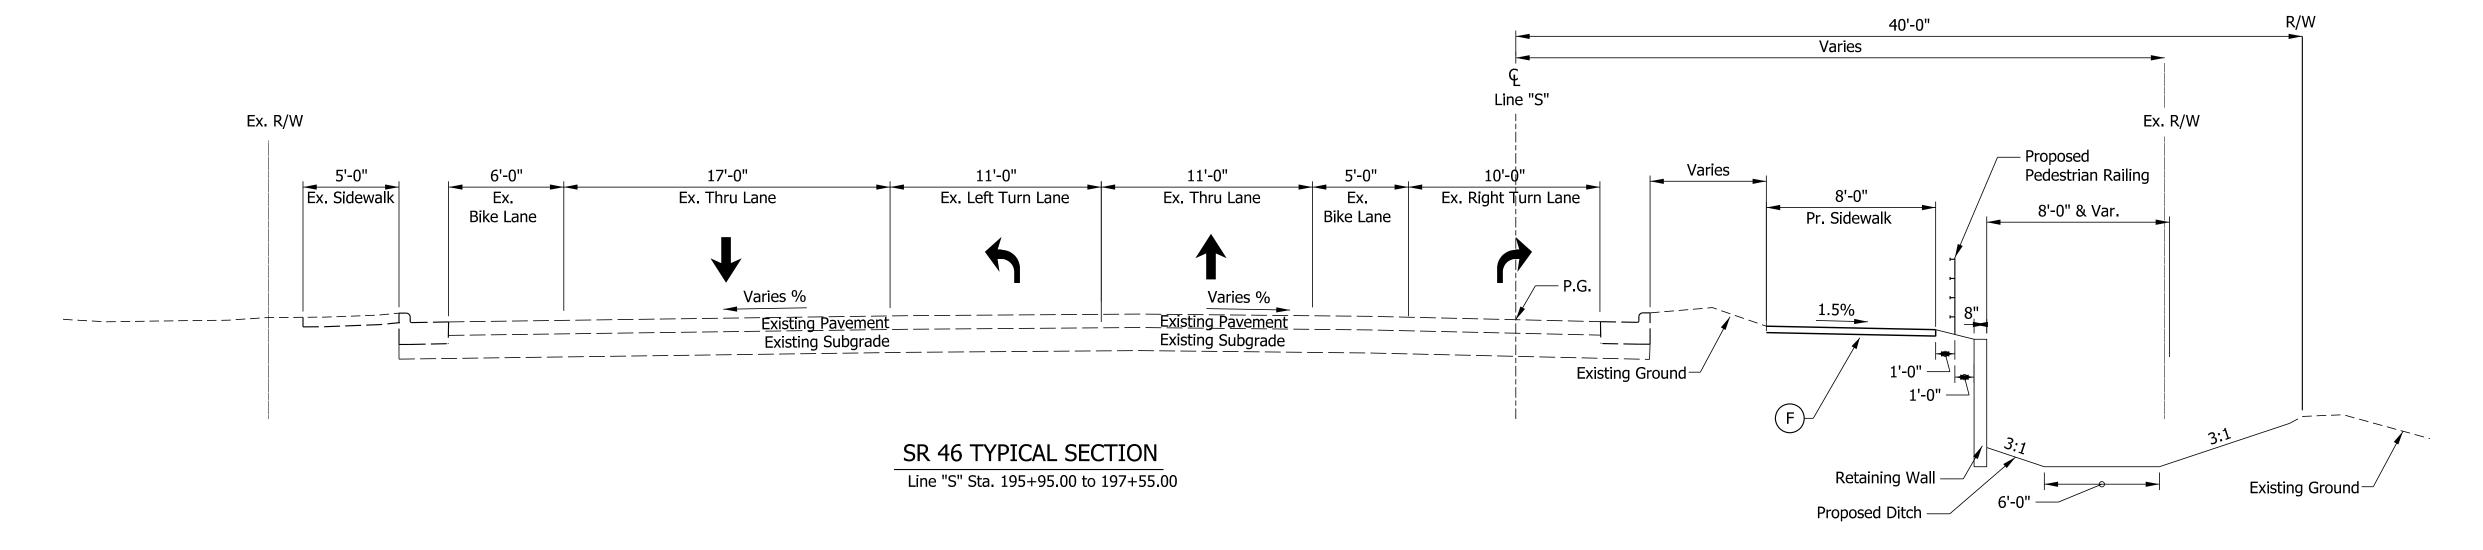
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 440 lb/syd QC/QA HMA, 3, 70, INTERMEDIATE, 12.5 mm
 440 lb/syd QC/QA HMA, 3, 70, BASE, 25.0 mm
- R MILL AND OVERLAY, 1.5" COMPOSED OF:: 165 lb/syd QC/QA HMA, 3, 70, SURFACE, 12.5 mm
- S SUBGRADE TREATMENT, TYPE IC
- O COMPACTED AGGREGATE, NO. 53
- (15) CURB AND GUTTER, CONCRETE, MODIFIED
- (F) SIDEWALK, CONCRETE
- 26) SODDING

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	DESIGNED: CMP 6/3/202	2 DRAWN: \$DWNBY\$	6/3/2022	TYPICAL SECTIONS	SURVEY BOOK Electronic	
	CUEDVED CMD	A CHECKED + DIMINOLIVE	6 /2 /2022	LINE "A"	CONTRACT	
	CHECKED: CMR 6/3/2022 CHECKED: \$DWNCHKBY\$ 6/3/20		6/3/2022		R-41465	

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SR 46 TYPICAL SECTION
Line "S" Sta. 197+55.00 to 199+38.00

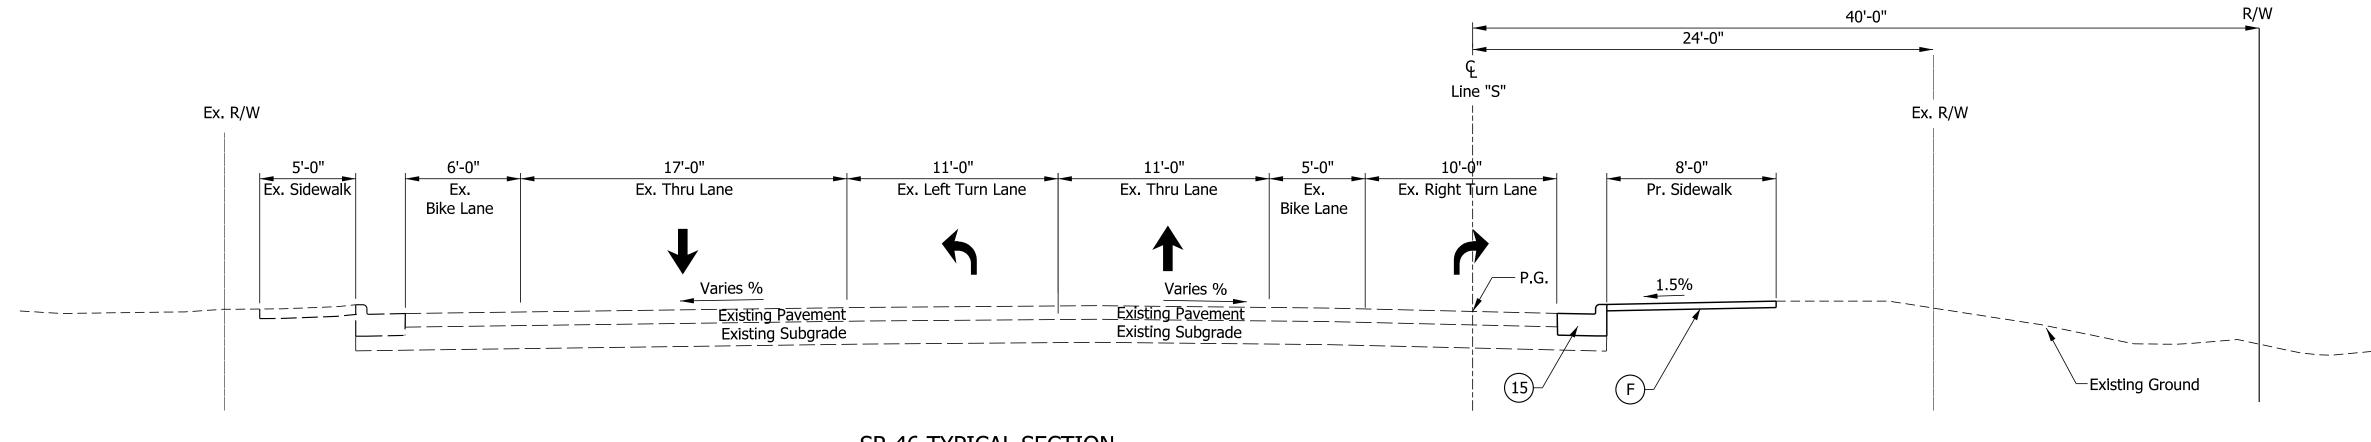



LEGEND


- K FULL DEPTH HMA COMPOSED OF:
 165 lb/syd QC/QA HMA, 3, 70, SURFACE, 12.5 mm
 440 lb/syd QC/QA HMA, 3, 70, INTERMEDIATE, 12.5 mm
 440 lb/syd QC/QA HMA, 3, 70, BASE, 25.0 mm
- R MILL AND OVERLAY, 1.5" COMPOSED OF:: 165 lb/syd QC/QA HMA, 3, 70, SURFACE, 12.5 mm
- S SUBGRADE TREATMENT, TYPE IC
- O COMPACTED AGGREGATE, NO. 53
- (15) CURB AND GUTTER, CONCRETE, MODIFIED
- (F) SIDEWALK, CONCRETE
- (26) SODDING


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MICH
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RECOMMENDED FOR APPROVAL	I	DESIGN ENGINEER	6/3/2022 DATE	INDIANA DEPARTMENT OF TRANSPORTATION	SCALE 1/2"=1'	BRIDGE FILE N/A DESIGNATION 1800208
DESIGNED: CMP	6/3/2022	DRAWN: \$DWNBY\$	6/3/2022	TYPICAL SECTIONS	SURVEY BOOK Electronic	SHEETS 12 of 21
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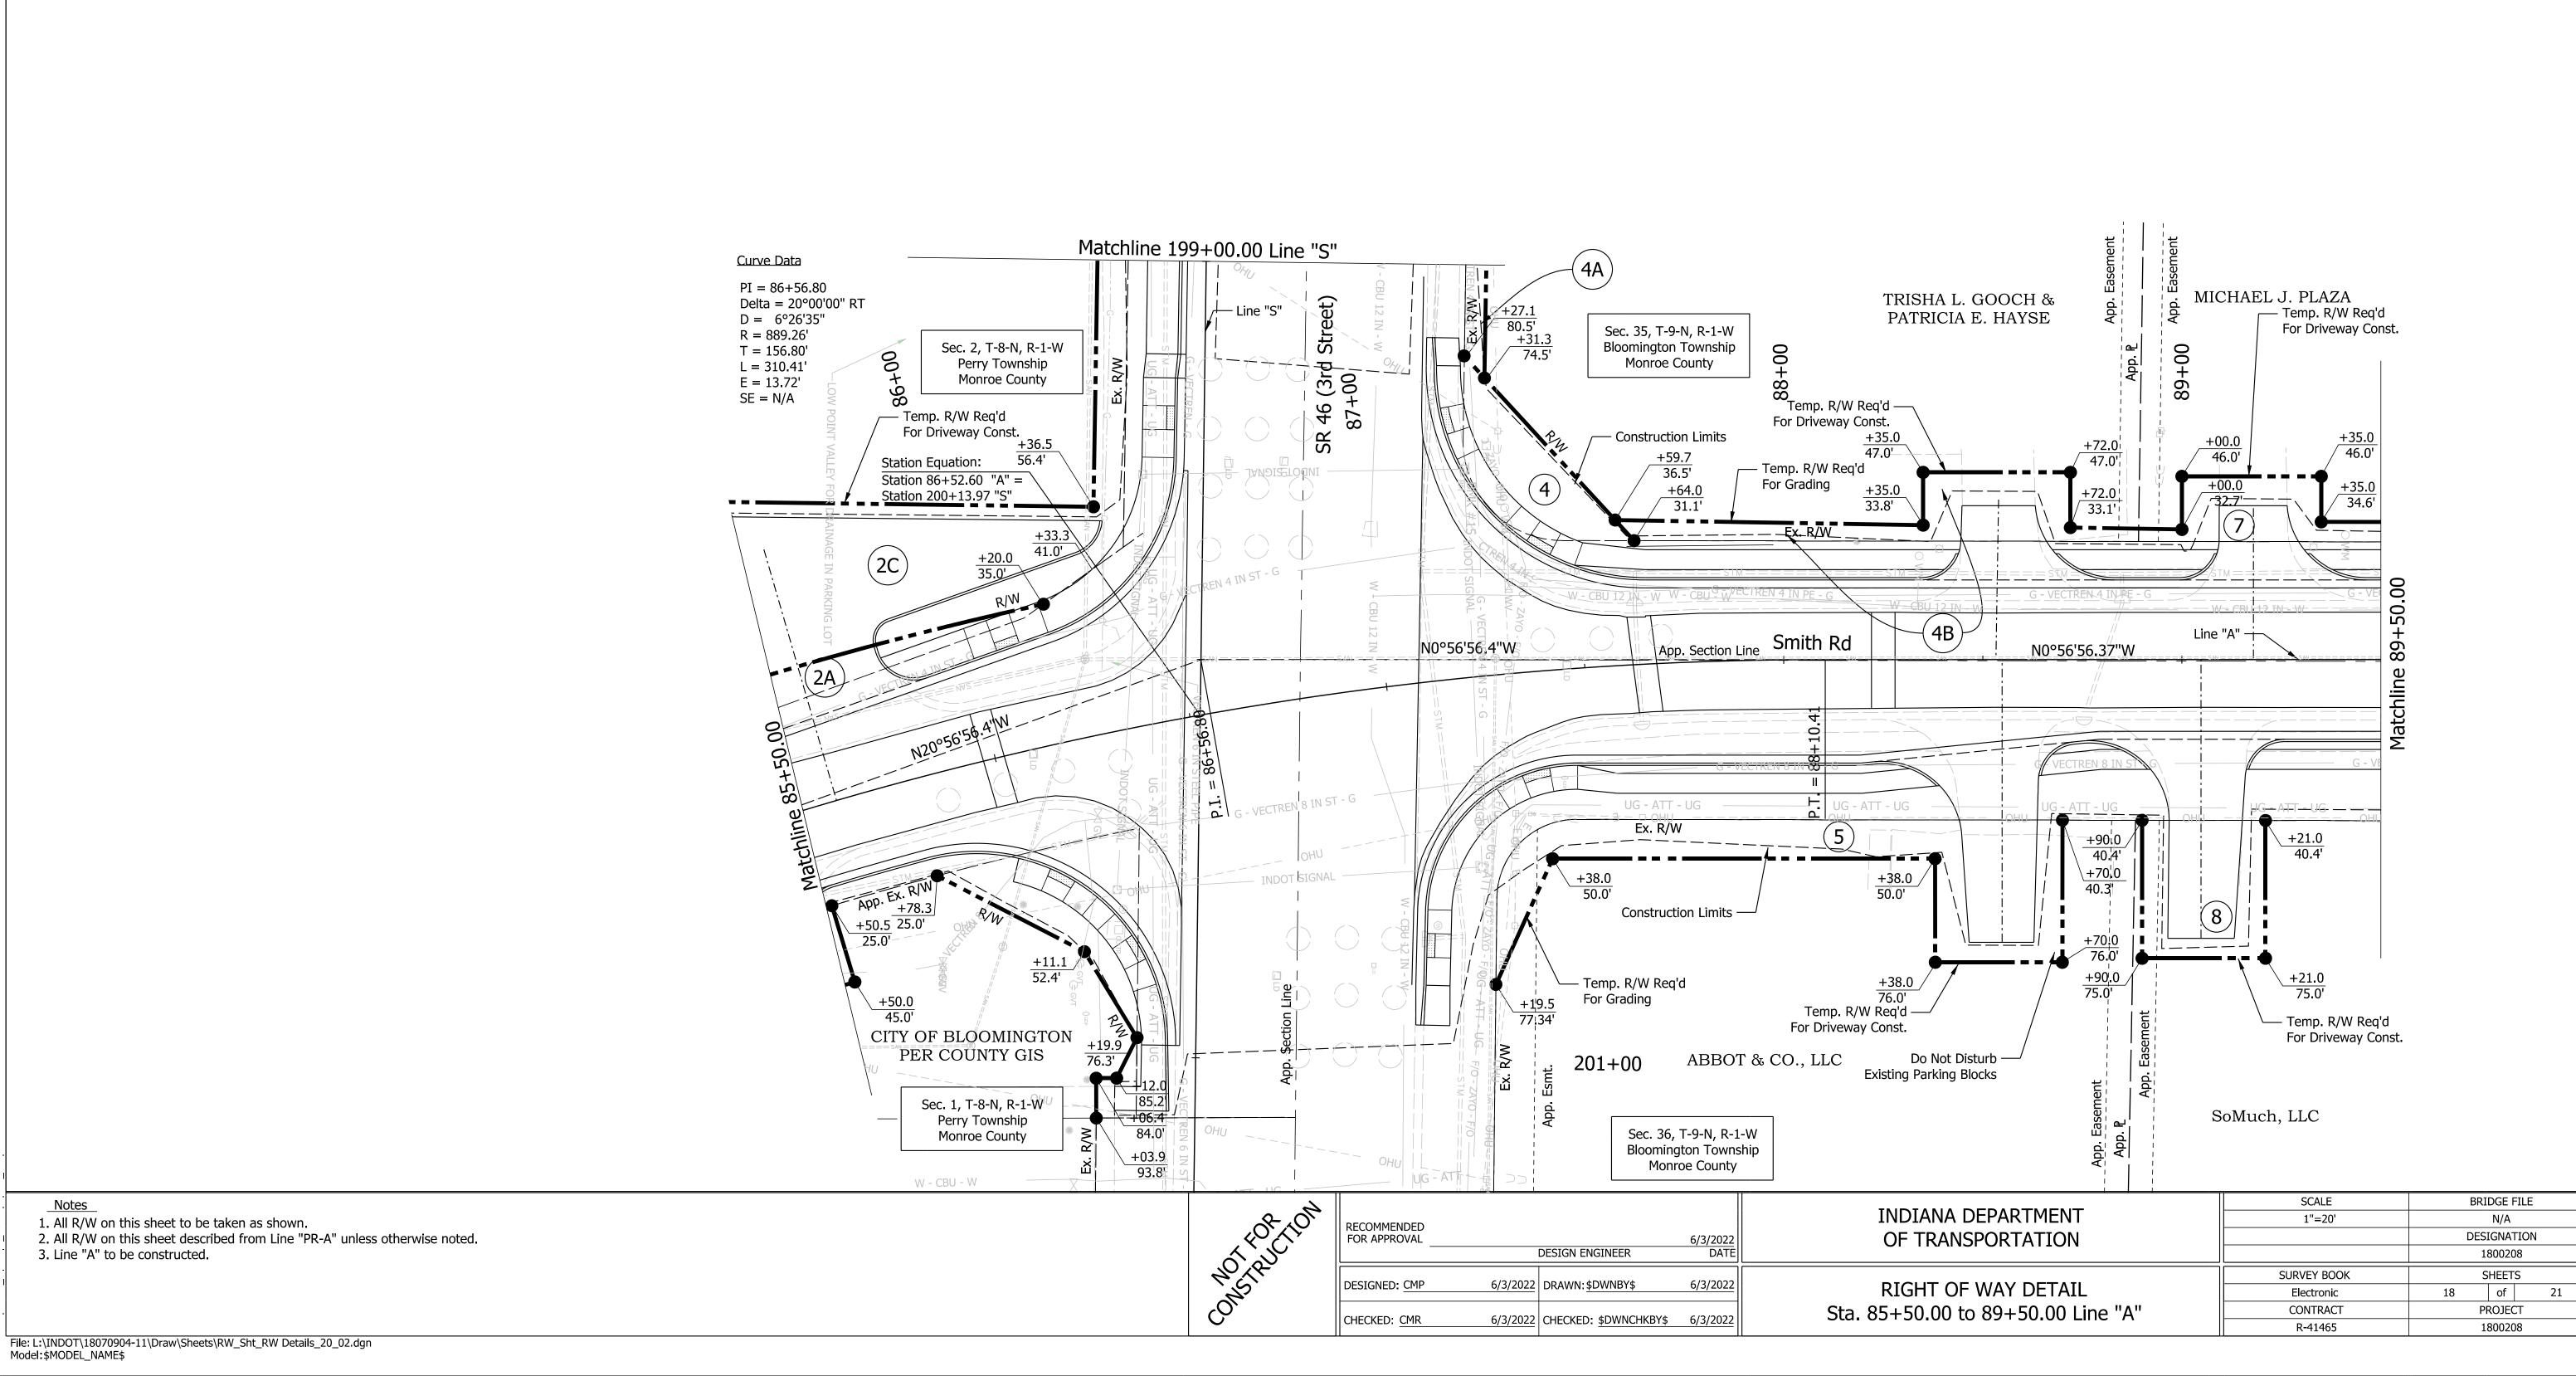





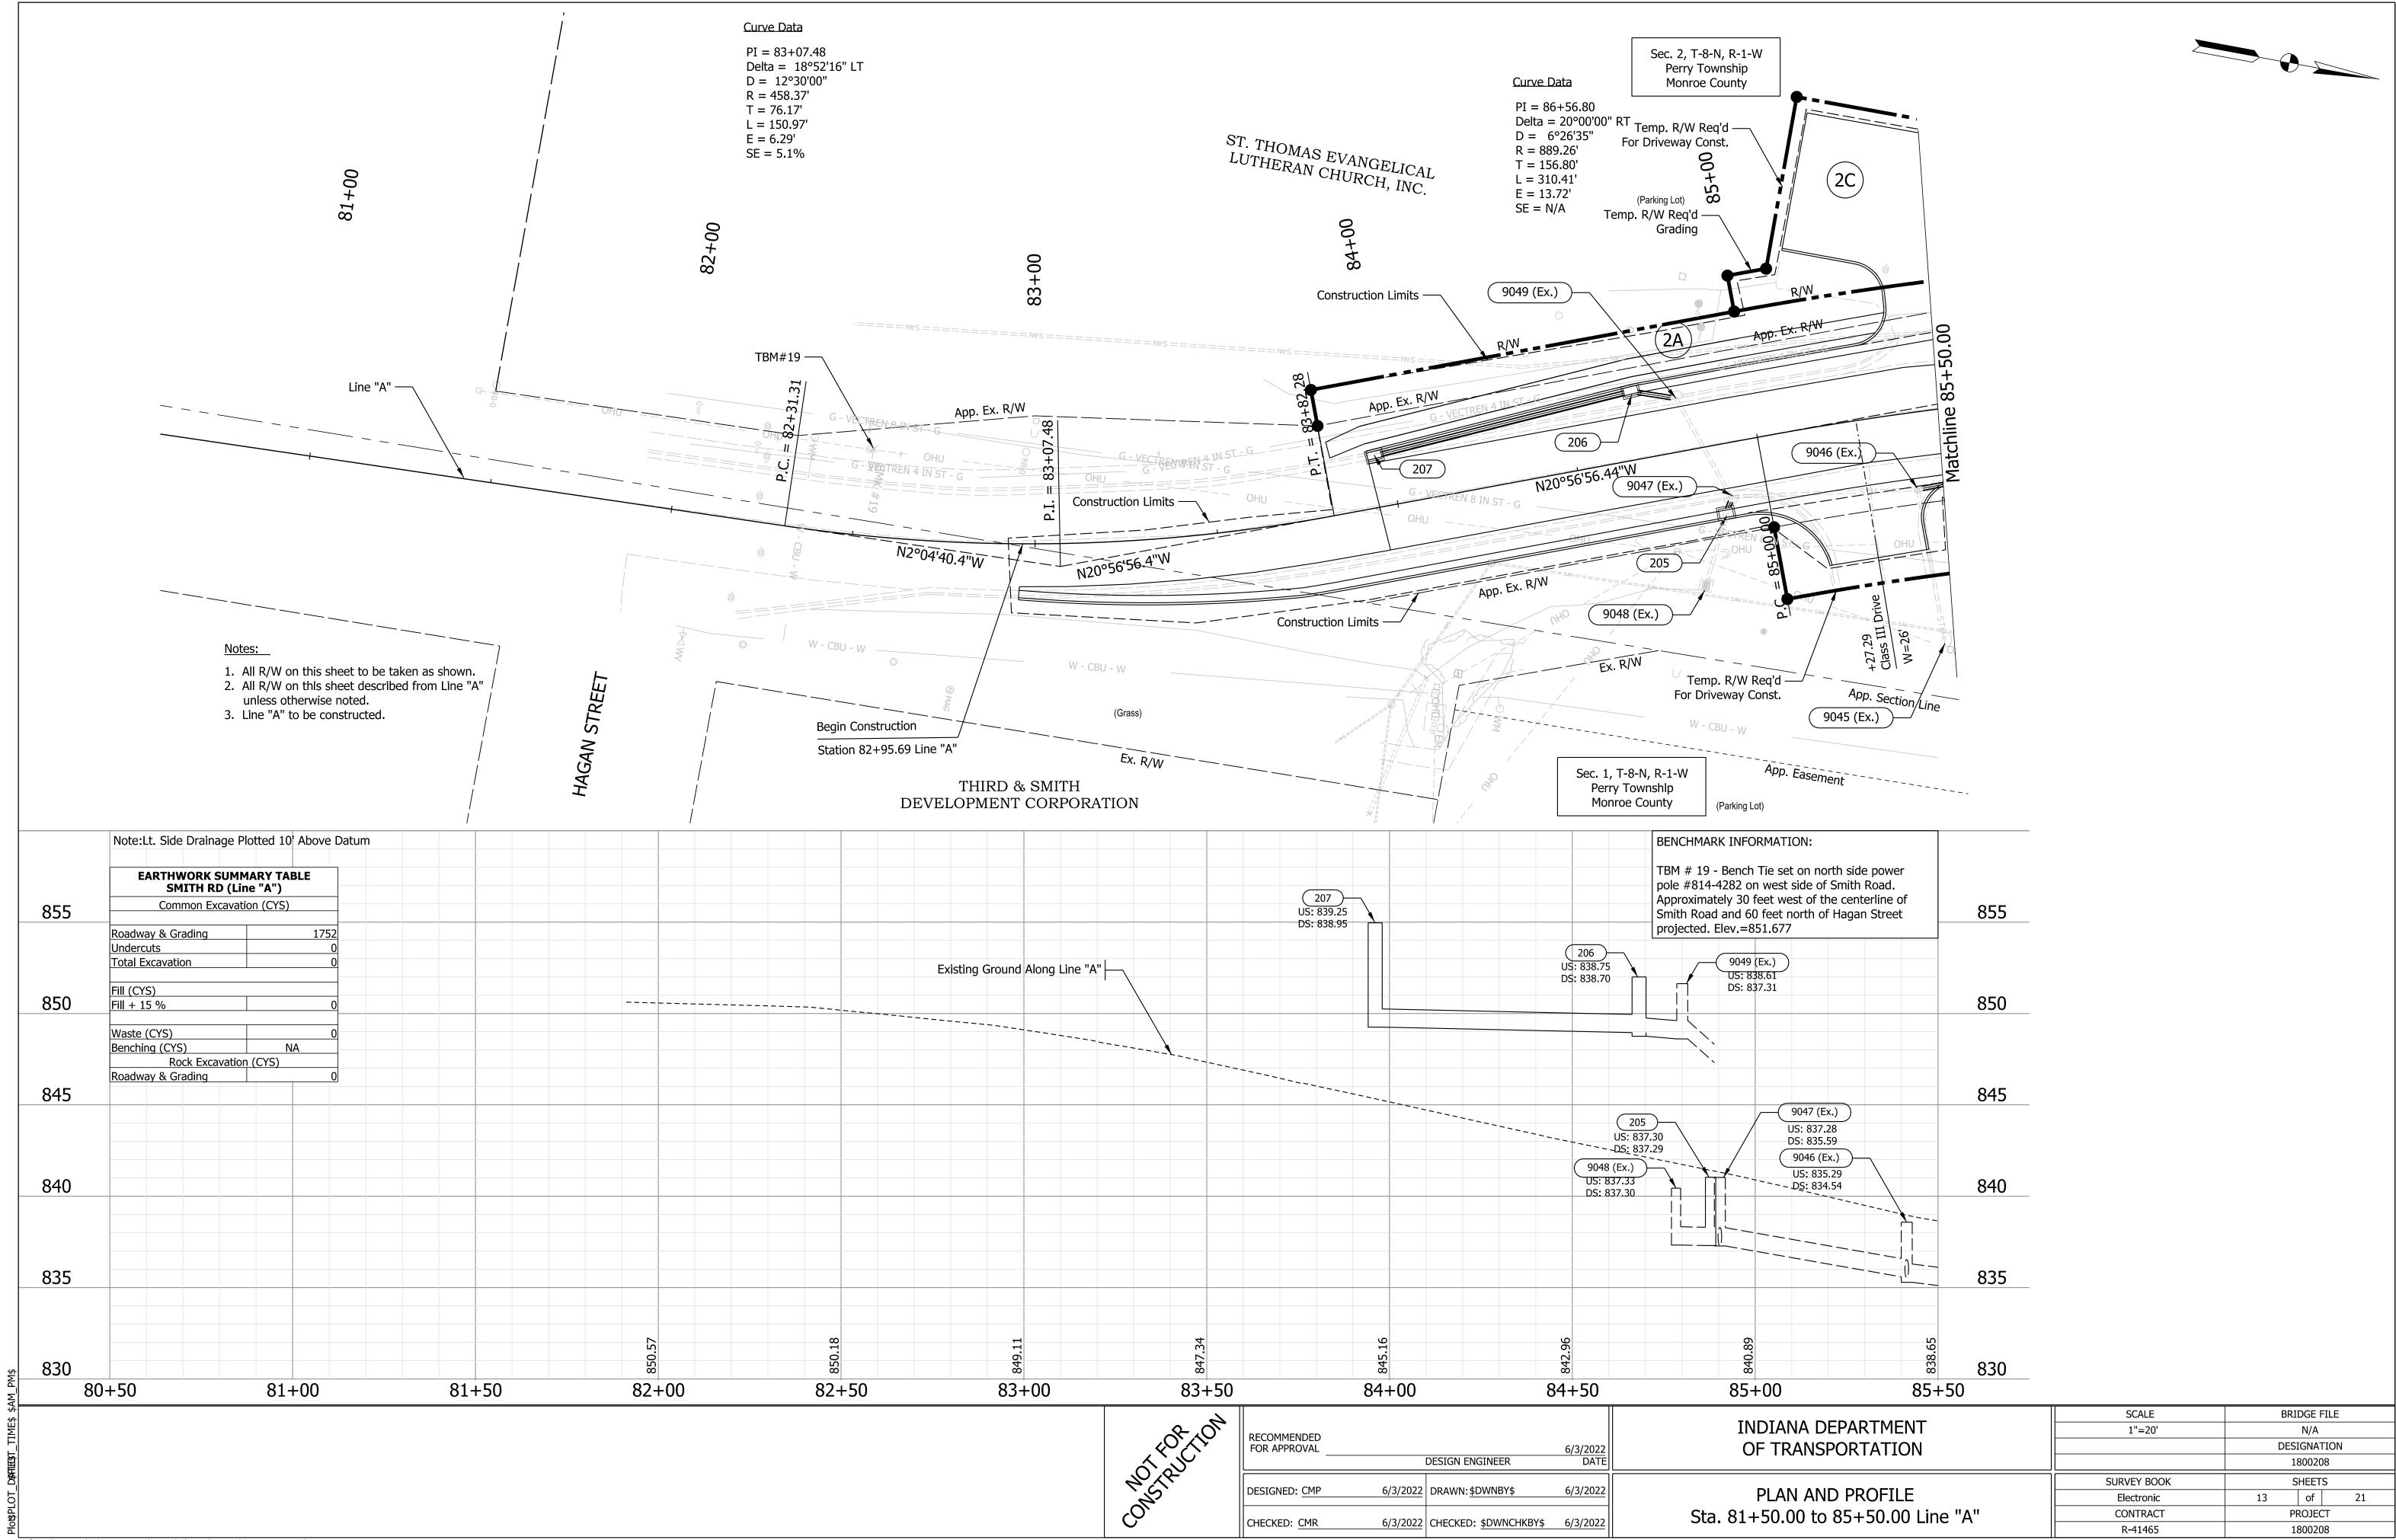


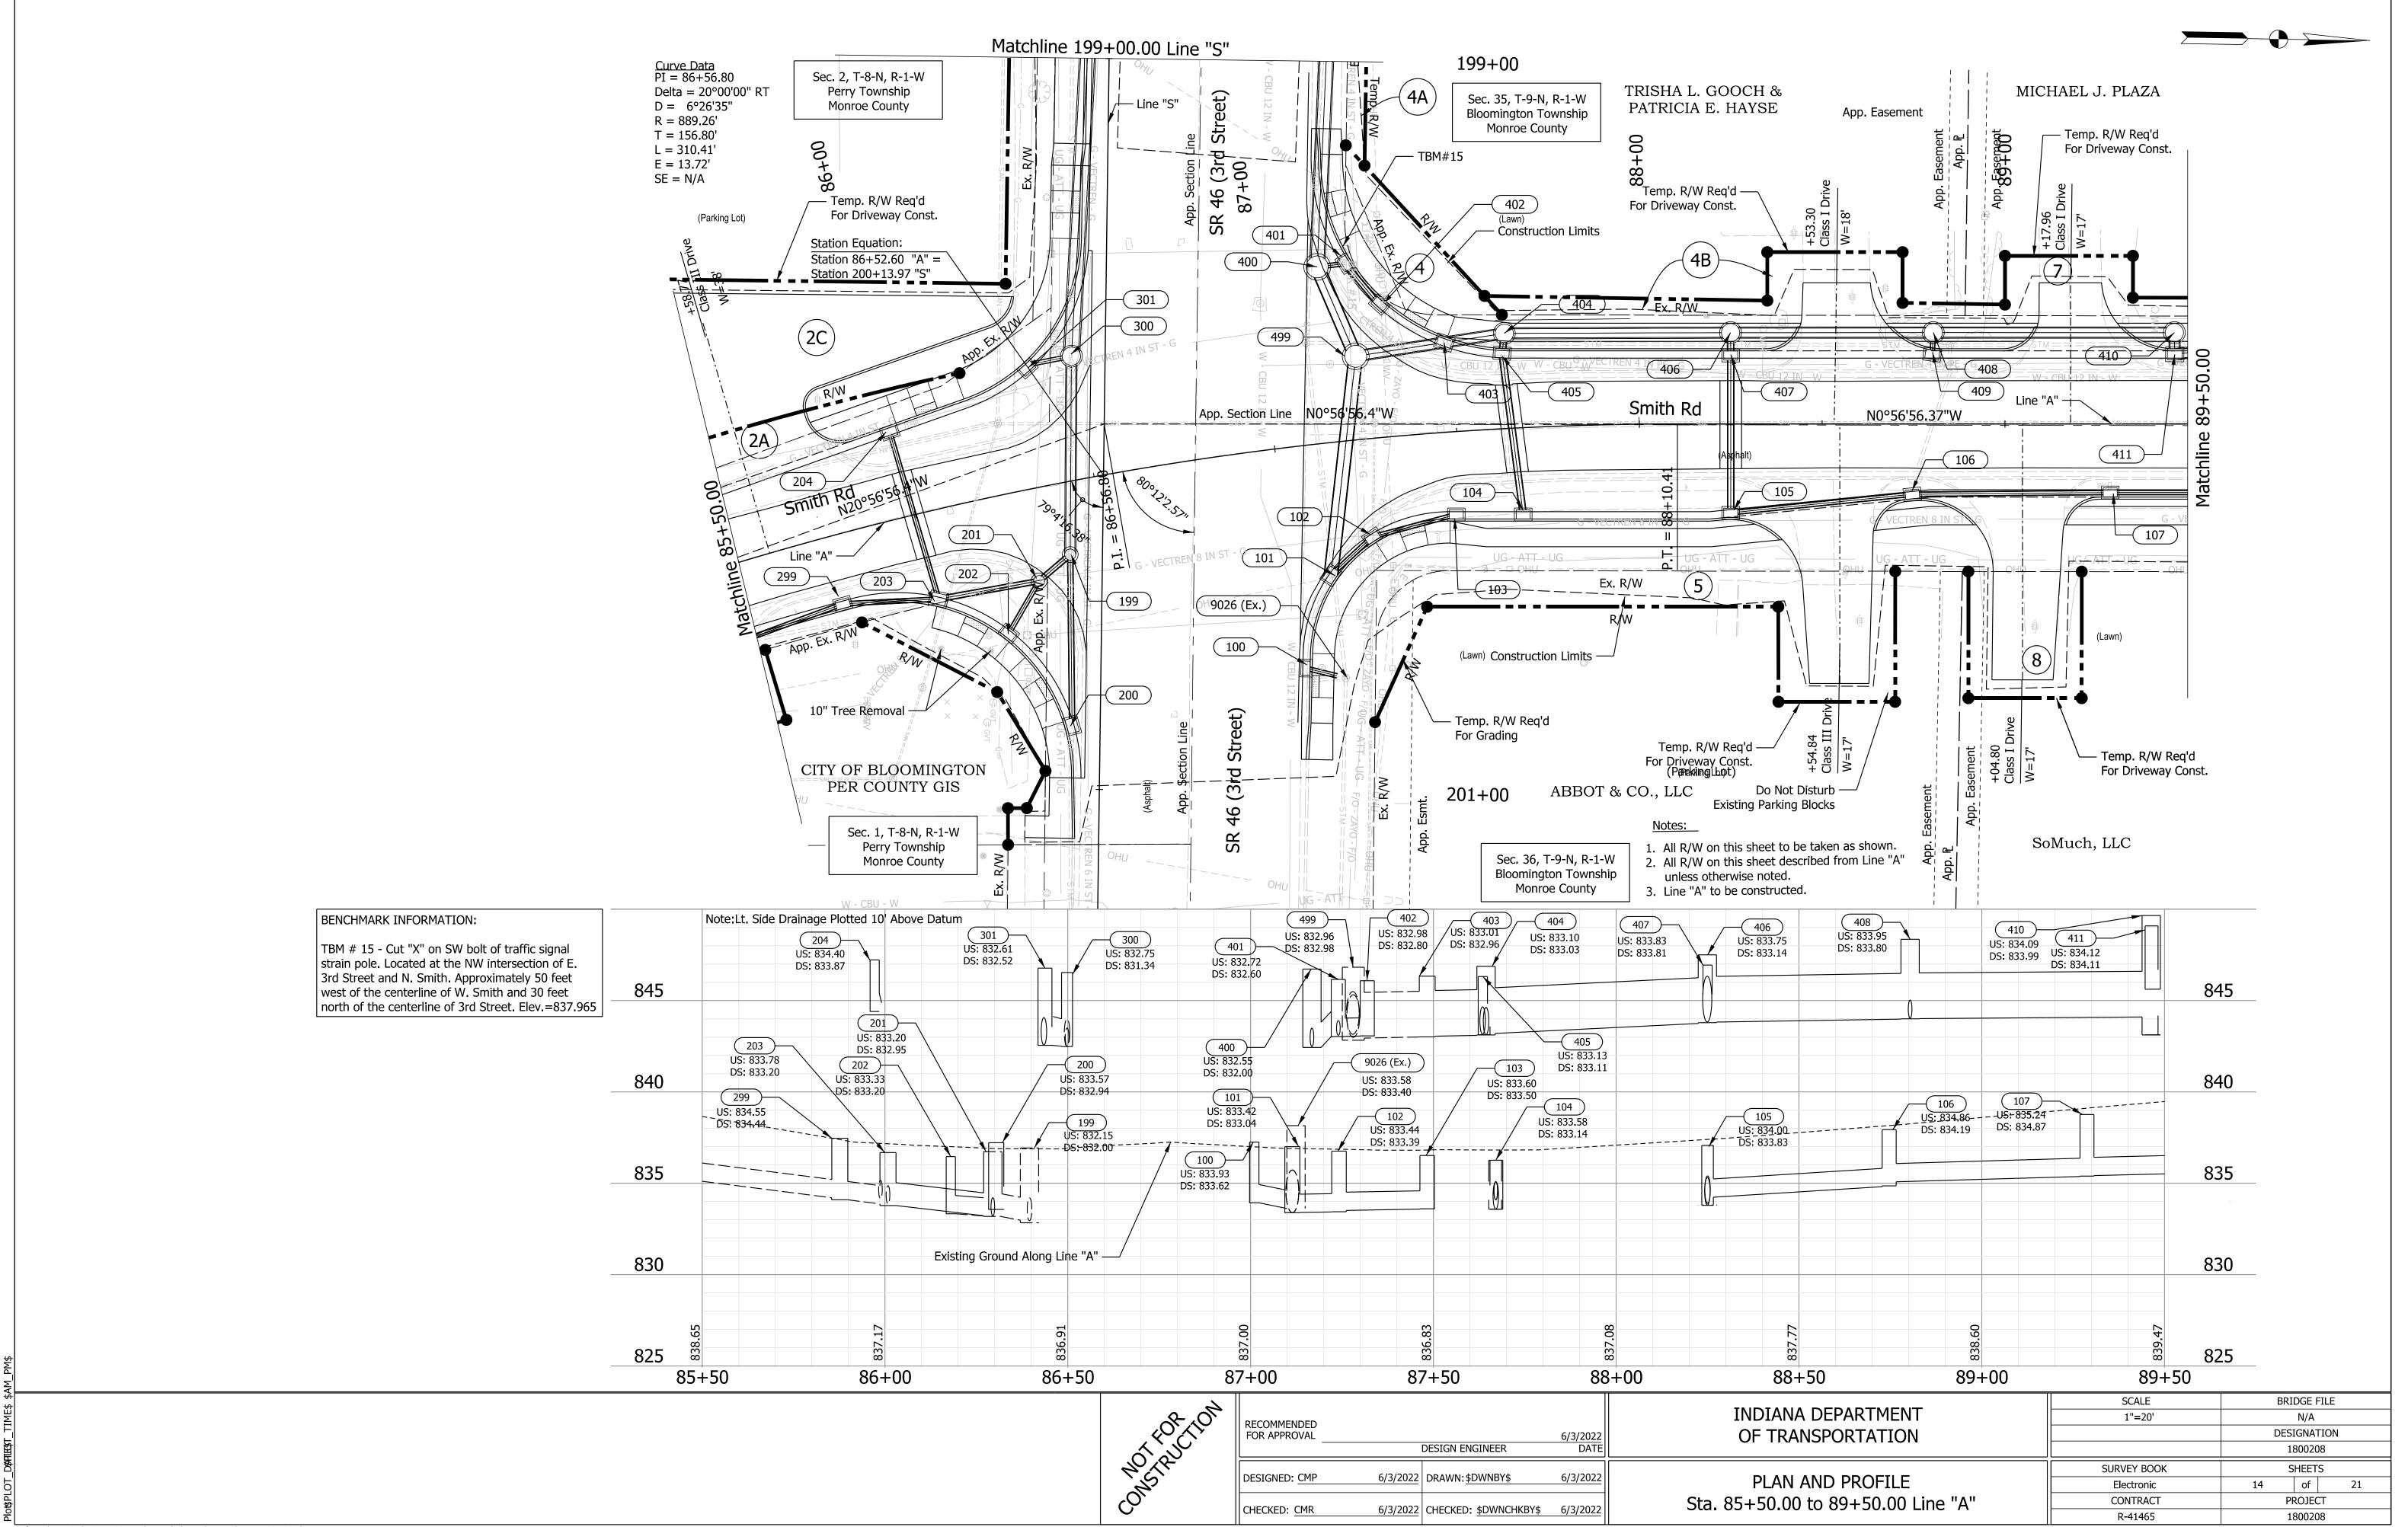

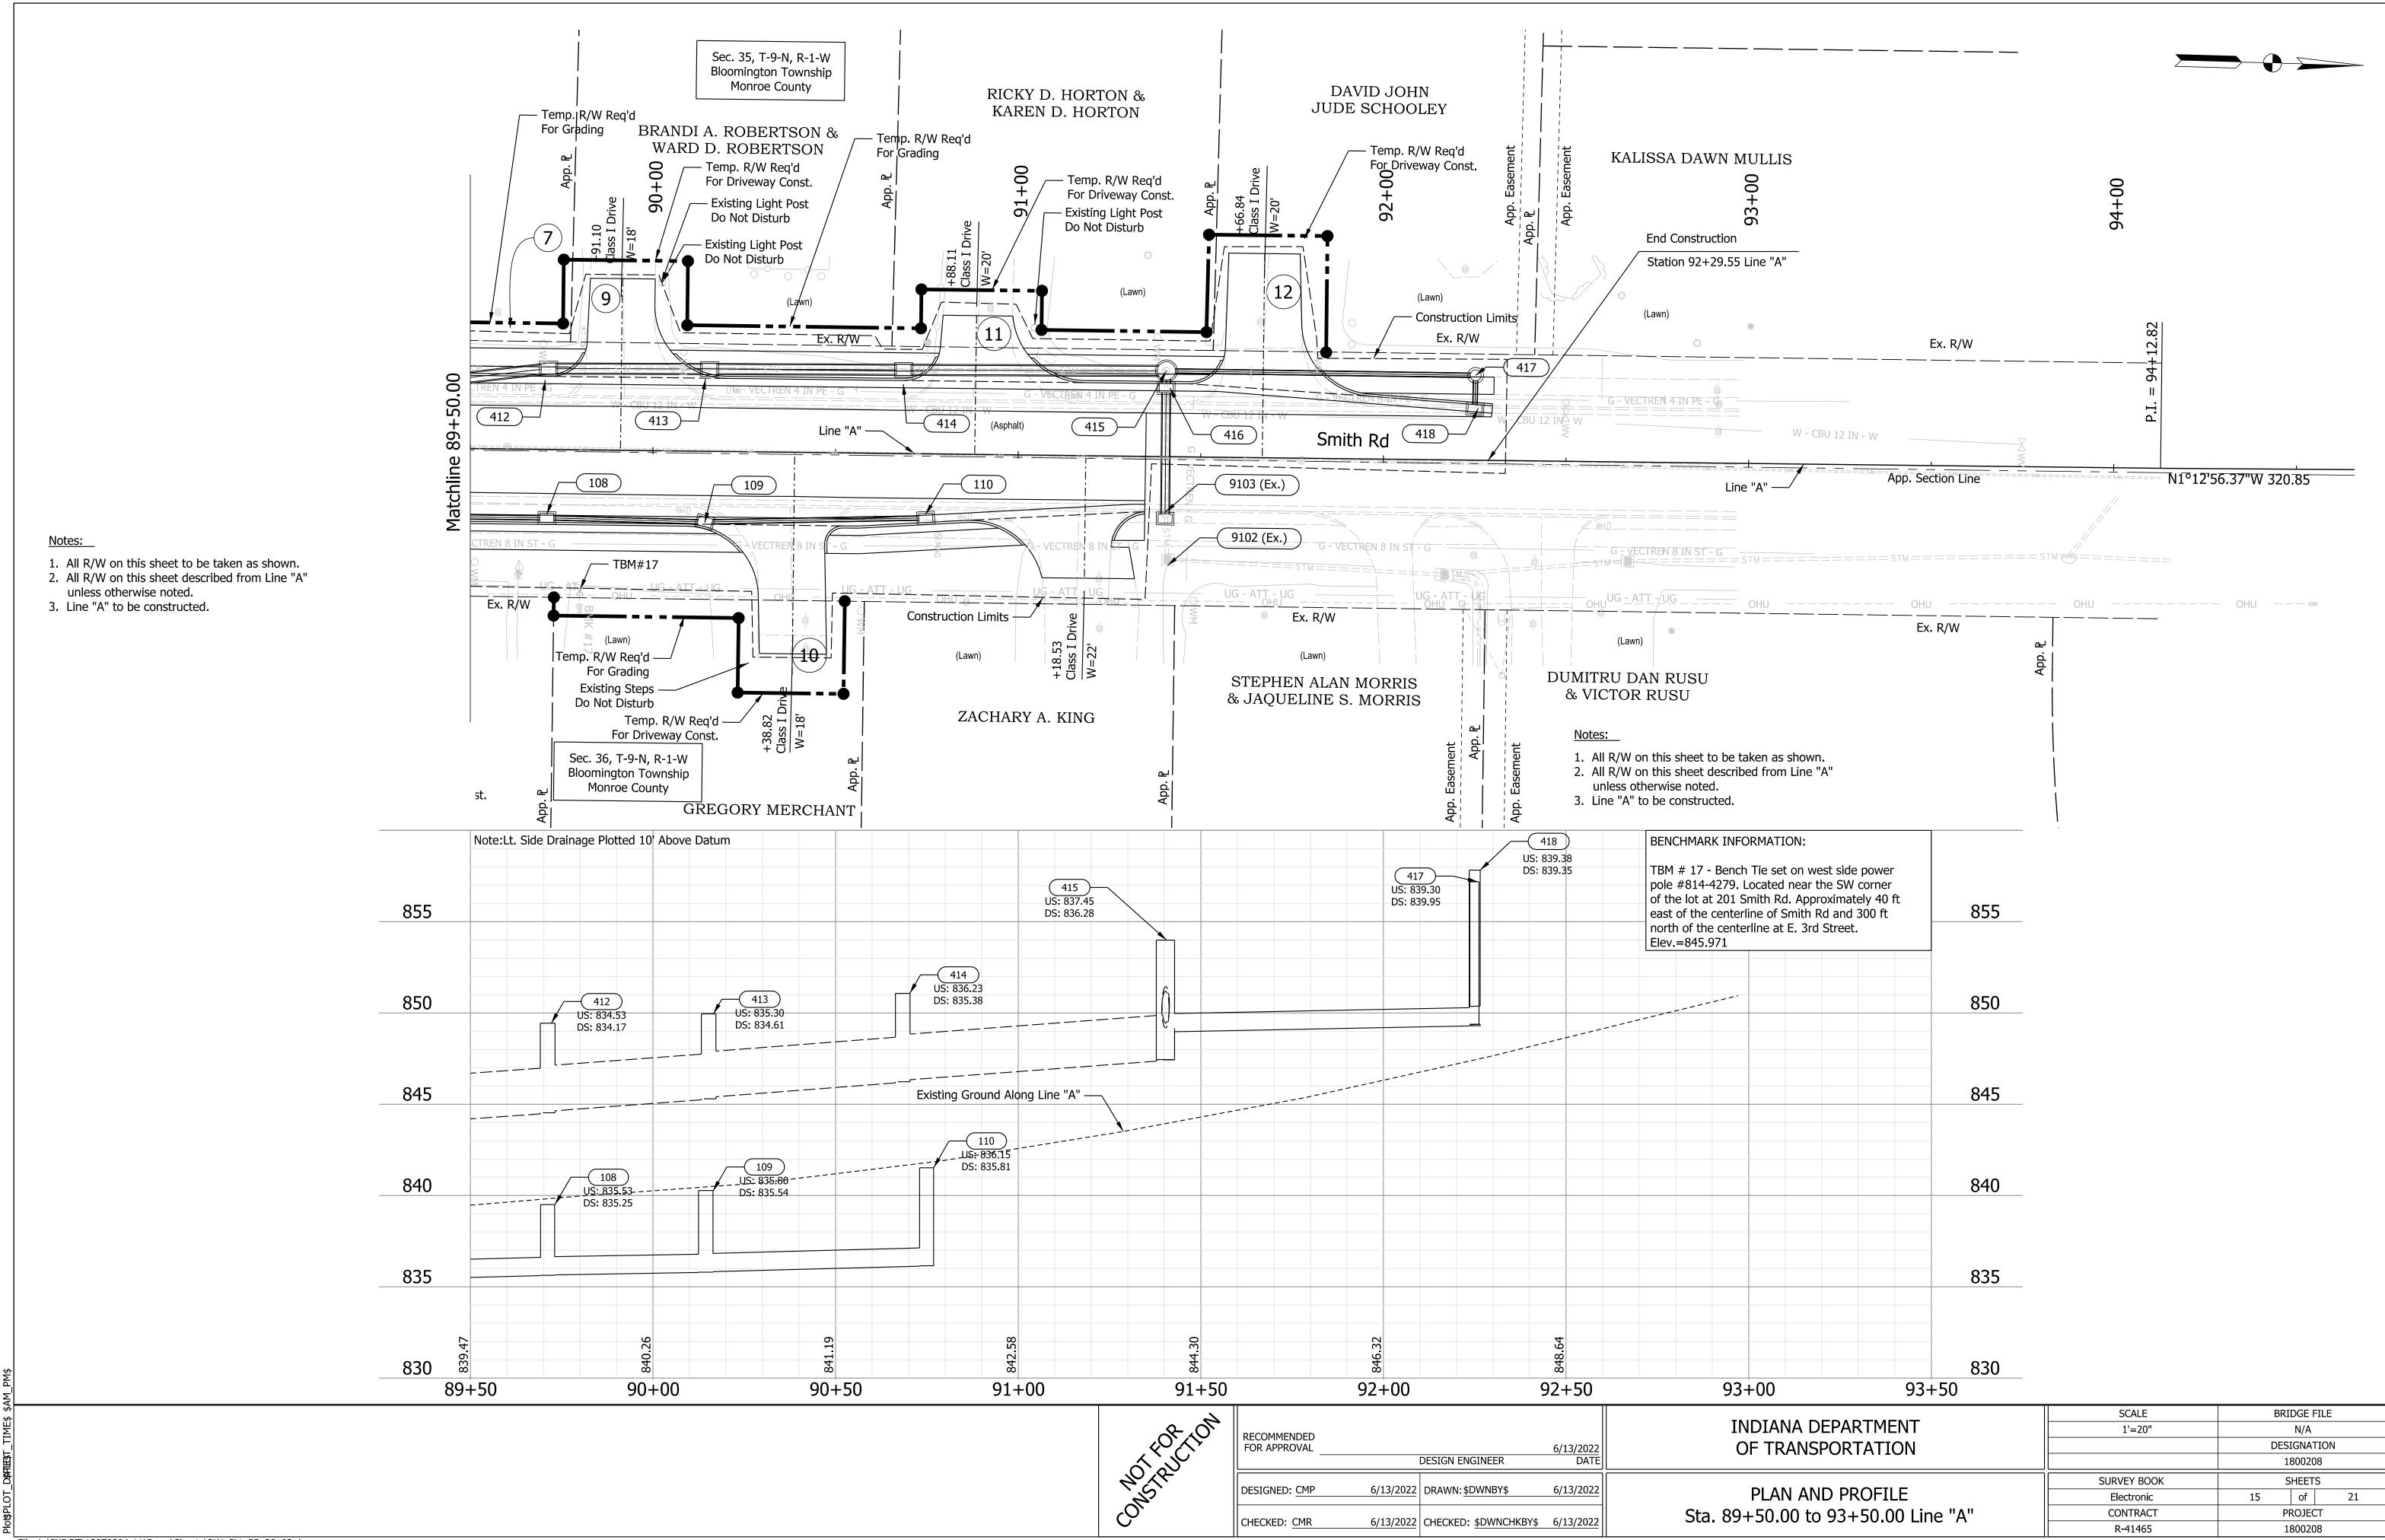

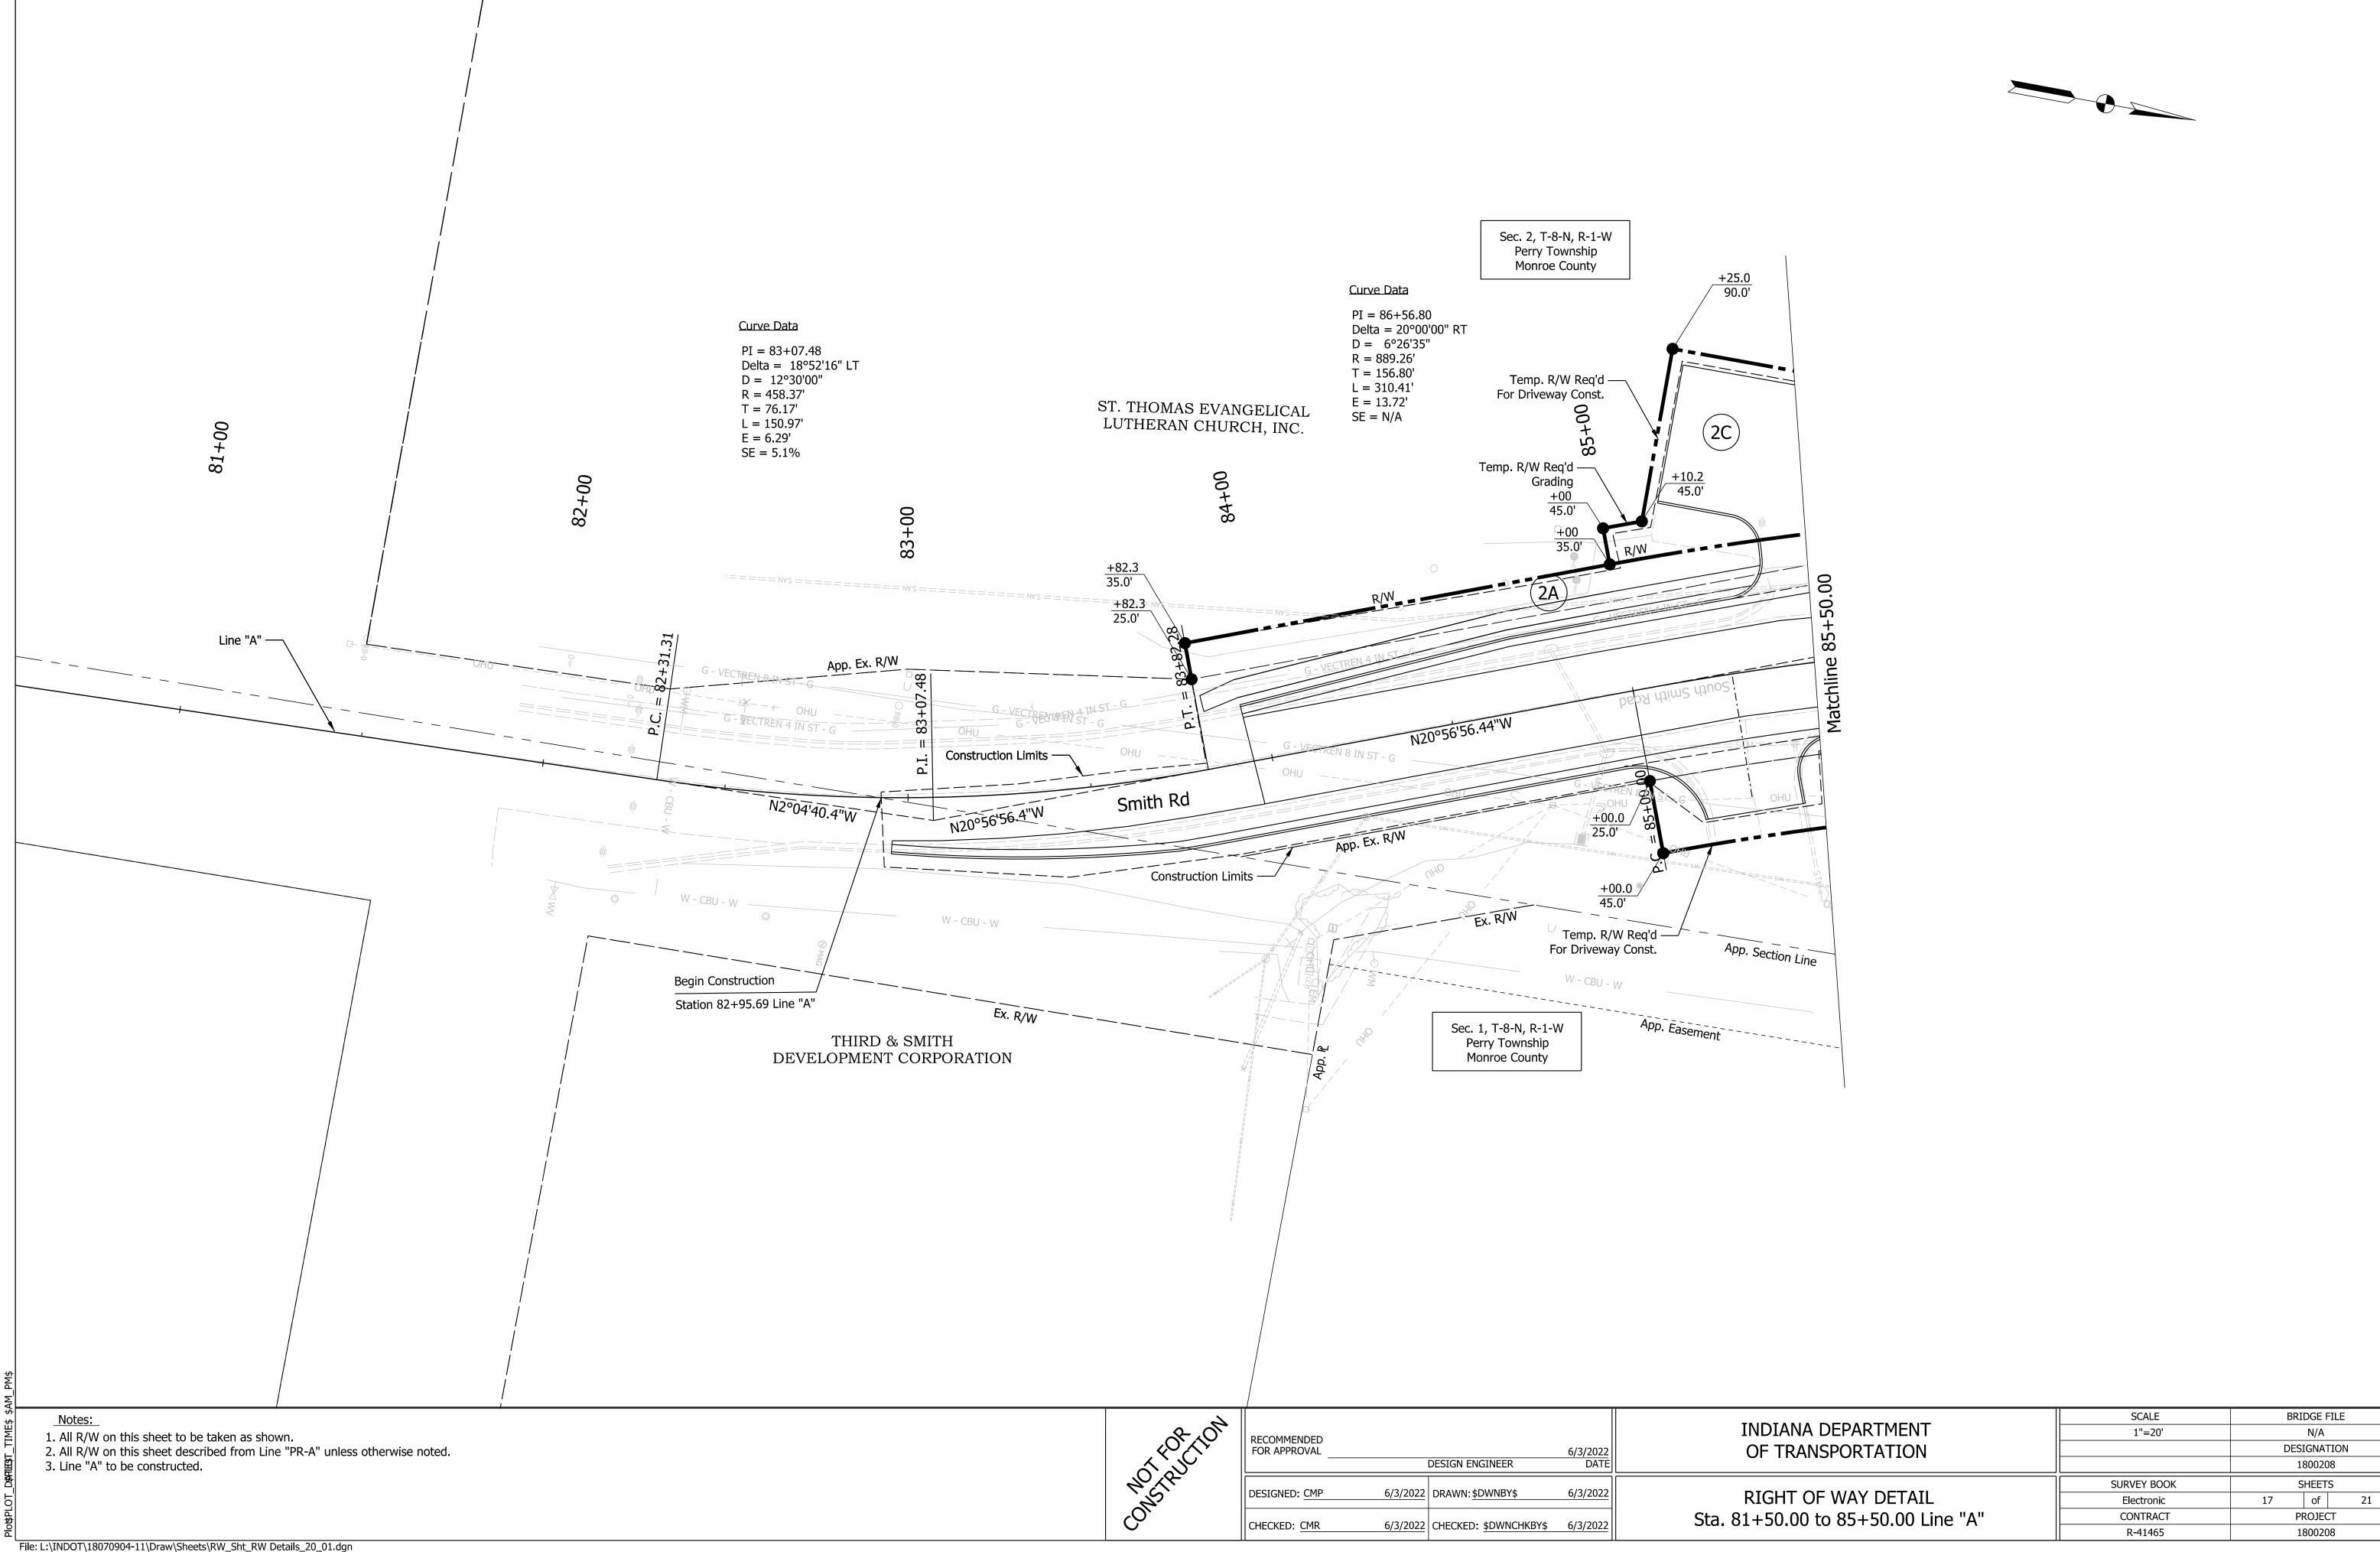

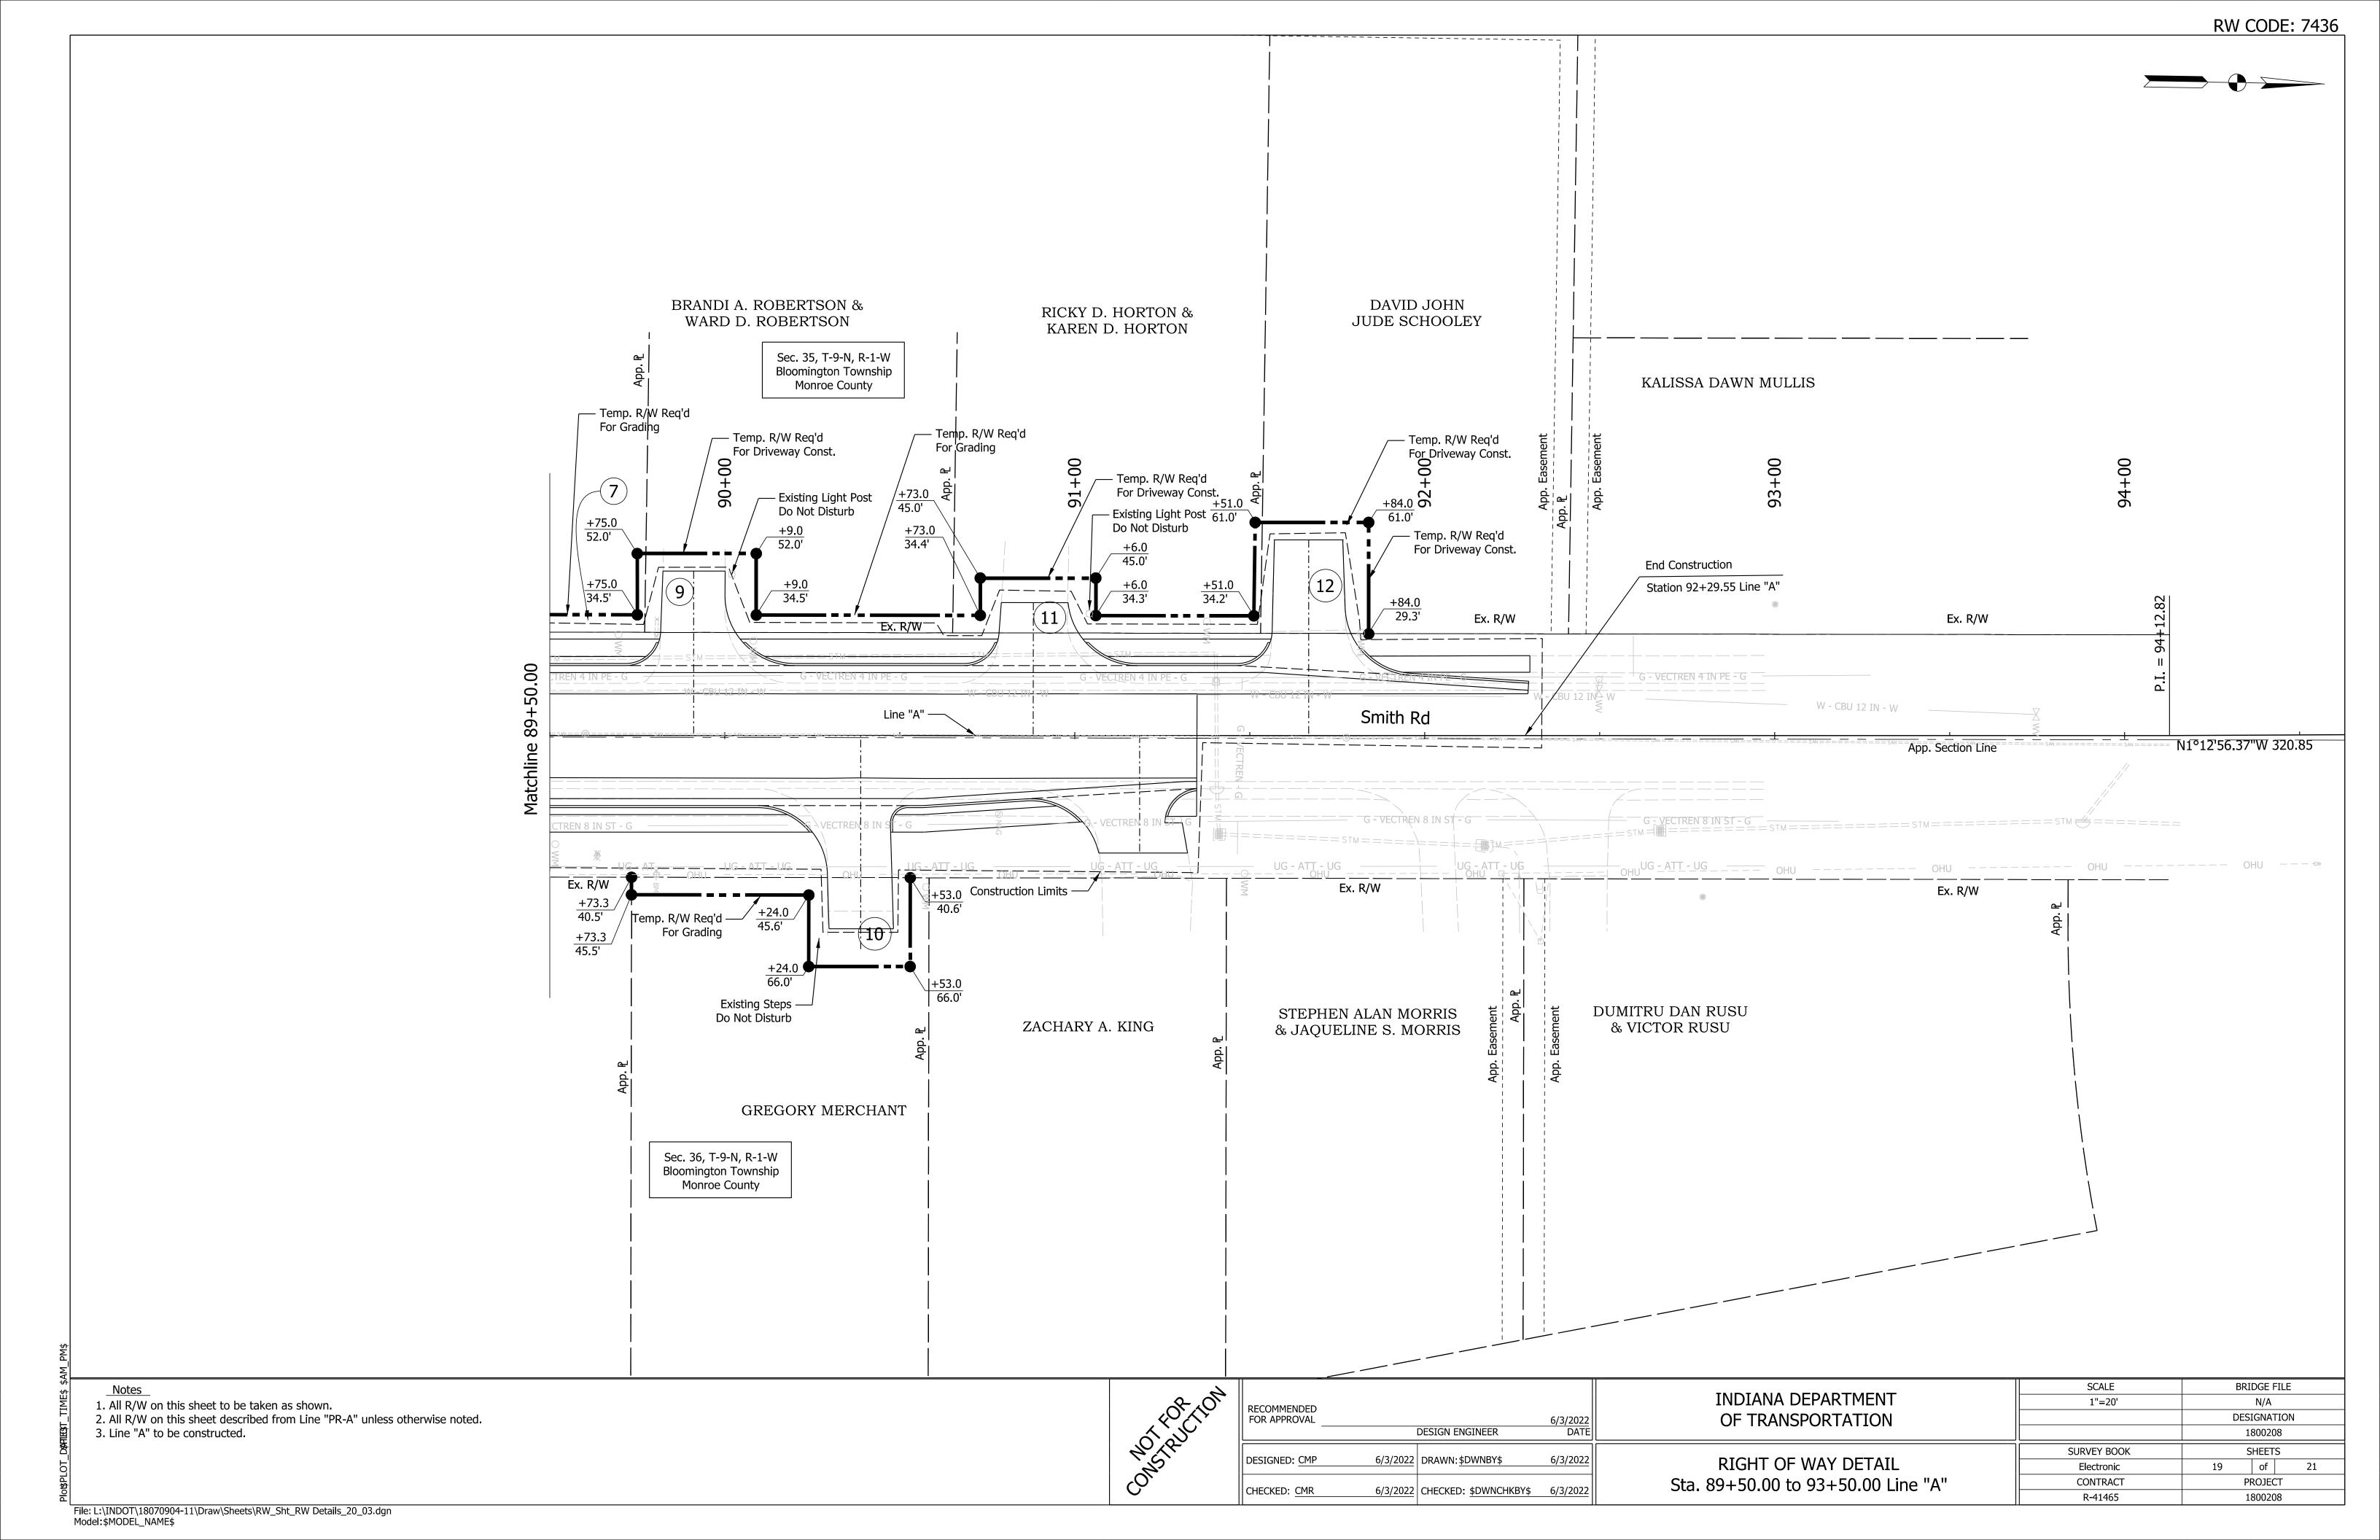

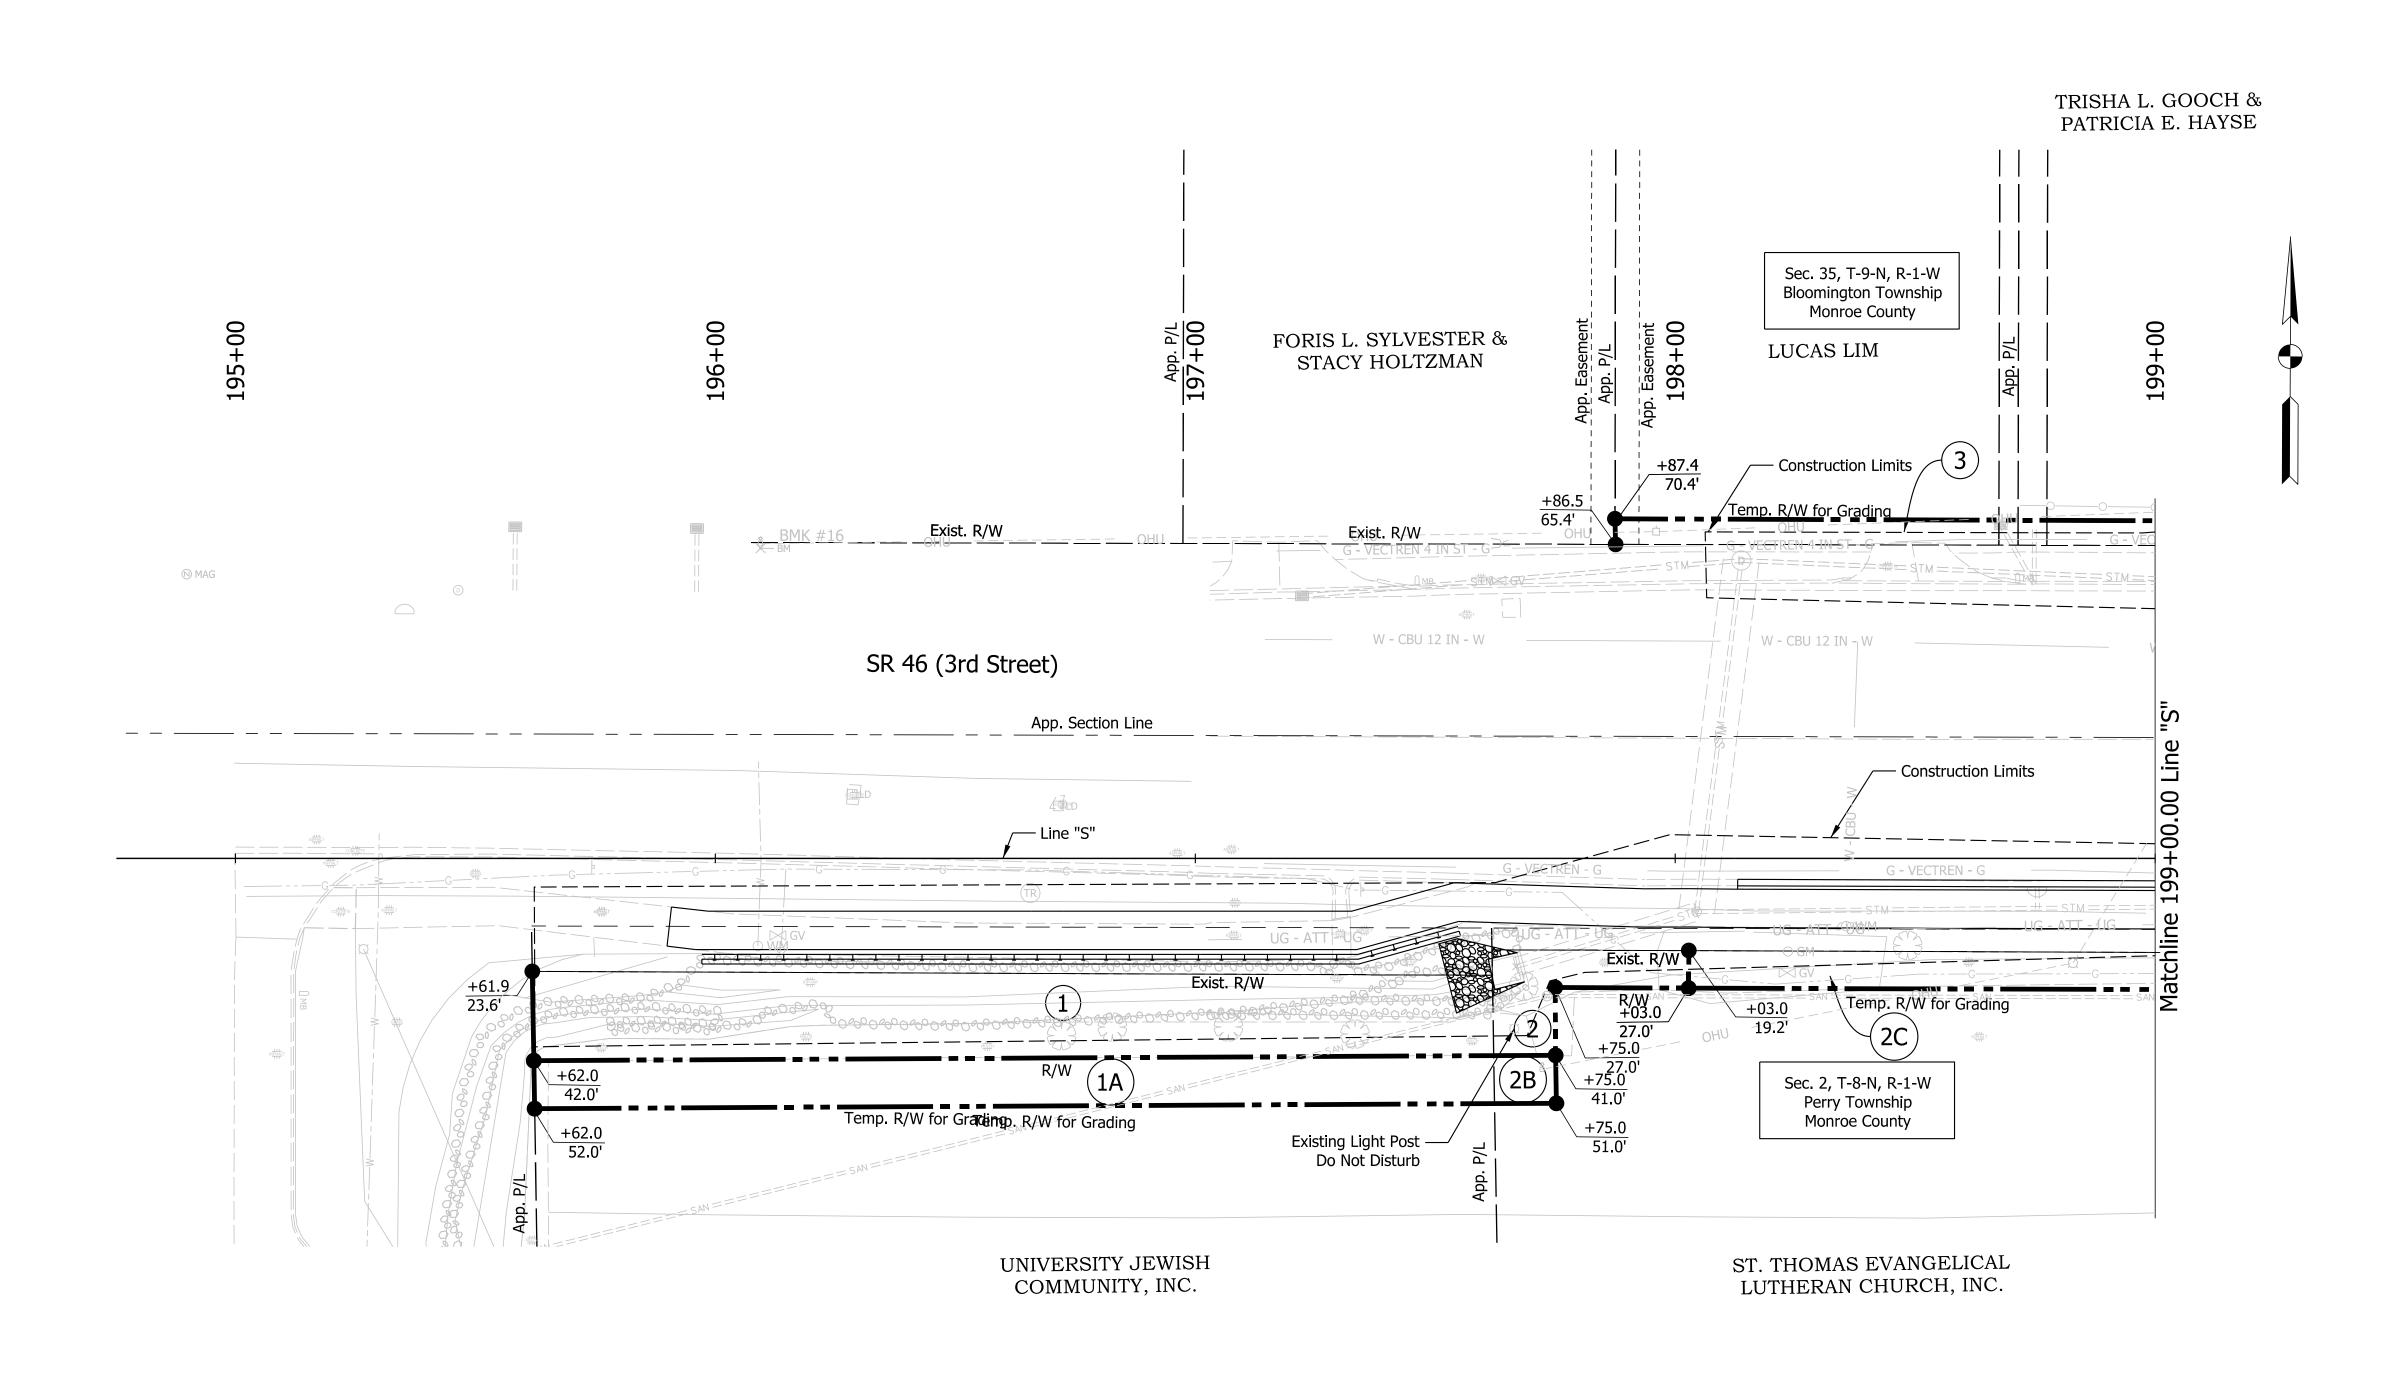

Notes

1. All R/W on this sheet to be taken as shown.

2. All R/W on this sheet described from Line "PR-A" unless otherwise noted.

3. Line "S" to be constructed.

COMPLICATION

RECOMMENDED FOR APPROVAL	1	DESIGN ENGINEER	6/3/2022 DATE	
DESIGNED: CMP	6/3/2022	DRAWN: \$DWNBY\$	6/3/2022	
CHECKED: CMR	6/3/2022	CHECKED: \$DWNCHKBY\$	6/3/2022	

INDIANA DEPARTMENT
OF TRANSPORTATION
RIGHT OF WAY DETAIL

Sta. 195+00.00 to 199+00.00 Line "S"

 SCALE
 BRIDGE FILE

 1"=20'
 N/A

 DESIGNATION

 1800208

 SURVEY BOOK
 SHEETS

 Electronic
 20 of 21

 CONTRACT
 PROJECT

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LOCATION	DESCRIPTION (APPROACH TYPE OR CLASS)	WIDTH	LENGTH	RADII	DISTANCE BEYOND R/W LINE	COMPACTED AGGREGATE BASE		CONCRETE	GRADE	EXCAVATION	HMA FOR APPROACHES	QC/QA-H SURFACE		S. PER SYI	OC/QA-HMA, 3, SURFACE, 12.5	HMA WEDGE AND LEVE TYPE B	MILLING, ASPHALT, 1 1/2 IN	ASPHALT FOR TACK COAT	SUBGRADE TREATMENT, TYPE	FULL DEPTH	PARTIAL DEPTH	PCCP APPROA	PE	SUBGRADE TREATMENT, TYPE	DENSE GRADED SUBBASE	GEOGRID TYPE IB	SURFACE	INTERMEDIATE	LIQUID ASHPHALT SEALANT	CURB RAMP, CONCRETE	CURB AND GUTTER, CONCRET	SIDEWALK, CONCRETE	CURB, CONCRETE, REMOVE	ND GUT	PAVEMENT, REMOVAL	REMAR
Smith Road - Line "PR-A"		FT	FT	FT	FT		SYS	SYS	1 2 % %	CUT FILL CYS CYS	165 275 SYS SYS				SYS		TONS	SYS		SYS	SYS	6 IN.		SYS	SYS	SYS	LFT	LFT	SYS	SYS	LFT	SYS	LFT	LFT S	YS	
Sta. 85+27.29 Rt.	Class III Drive	26.00	17.72	10 / 20	0 13																															
Sta. 85+58.77 Lt.	Class III Drive				0 39.86																															
Sta. 88+53.30 Lt.	Class I Drive	18.00	20.30	10 / 20	0 10.58	3																														
Sta. 88+54.84 Rt.	Class III Drive	17.00	49.10	10 / 20	0 30.7																															
Sta. 89+04.80 Rt.	Class I Drive	17.00	50.00	10 / 20	0 29.61	-																														
Sta. 89+17.96 Lt.	Class I Drive	18.00	18.00	10 / 20	0 8.38																															
Sta. 89+91.10 Lt.	Class I Drive				0 17.5																															
Sta. 90+38.82 Rt.	Class I Drive				0 20.39																															
Sta. 90+88.11 Lt.	Class I Drive				0 8.66																															
Sta. 91+18.53 Rt.	Class I Drive	22.00																																		
Sta. 91+61.84 Lt.	Class I Drive	20.00	37.55	10 / 20	0 26.7																															
															-,01										TNIF	T A N I A	DEDAD	TMENT	_				SCALE 333 ' / in.			GE FILE N/A

MATRICITIO

RECOMMENDED FOR APPROVAL												
DESIGNED: CMP	6/3/2022	DRAWN: \$DWNBY\$	6/3/2022									
CHECKED: CMR	6/3/2022	CHECKED: \$DWNCHKBY\$	6/3/2022									

INDIANA DEPARTMENT OF TRANSPORTATION

APPROACH TABLE

 83.3333 ' / in.
 N/A

 DESIGNATION
 1800208

 SURVEY BOOK
 SHEETS

 Electronic
 21 of 21

 CONTRACT
 PROJECT

1800208

R-41465