STRUCTURE	TYPE	SPAN AND SKEW	OVER	STATION
340-11-10492	Precast Concrete Three-Sided Structure	36'-0" Span x 12'-0" Rise Skew: None	PURDY RUN	438+82.50 Line "A"

KIN C	DESIGNATION NUMBERS
1900339	SMALL STRUCTURE REPLACEMENT on S.R. 46
2000877	SMALL STRUCTURE MAINTENANCE AND REPAIR on U.S. 40

LEAD DESIGNATION NUMBERS

PROJECT LOCATION

STAGE 2 PLANS


Feb. 17, 2023

STRUCTURE 340-11-10492 STA. 438+82.50 Line "A"

> BEGIN PROJECT NO. 1900176 STA. 437+84.14 LINE "A"

1900176 BRIDGE REPLACEMENT on S.R. 340 over PURDY RUN

INDIANA DEPARTMENT OF TRANSPORTATION

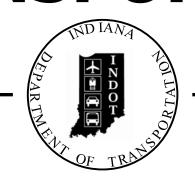

BRIDGE PLANS

FOR SPANS OVER 20 FEET


ROUTE: S.R. 340 AT: RP 2+00

PROJECT NO. 1900176 P.E.

1900176 R/W

1900176 CONST.


Bridge Replacement on SR 340 over Purdy Run, Located 2.09 Miles East of W. U.S. 40 Jct. in Section 5, T-12-N, R-7-W, Posey Township, Clay County, Indiana.

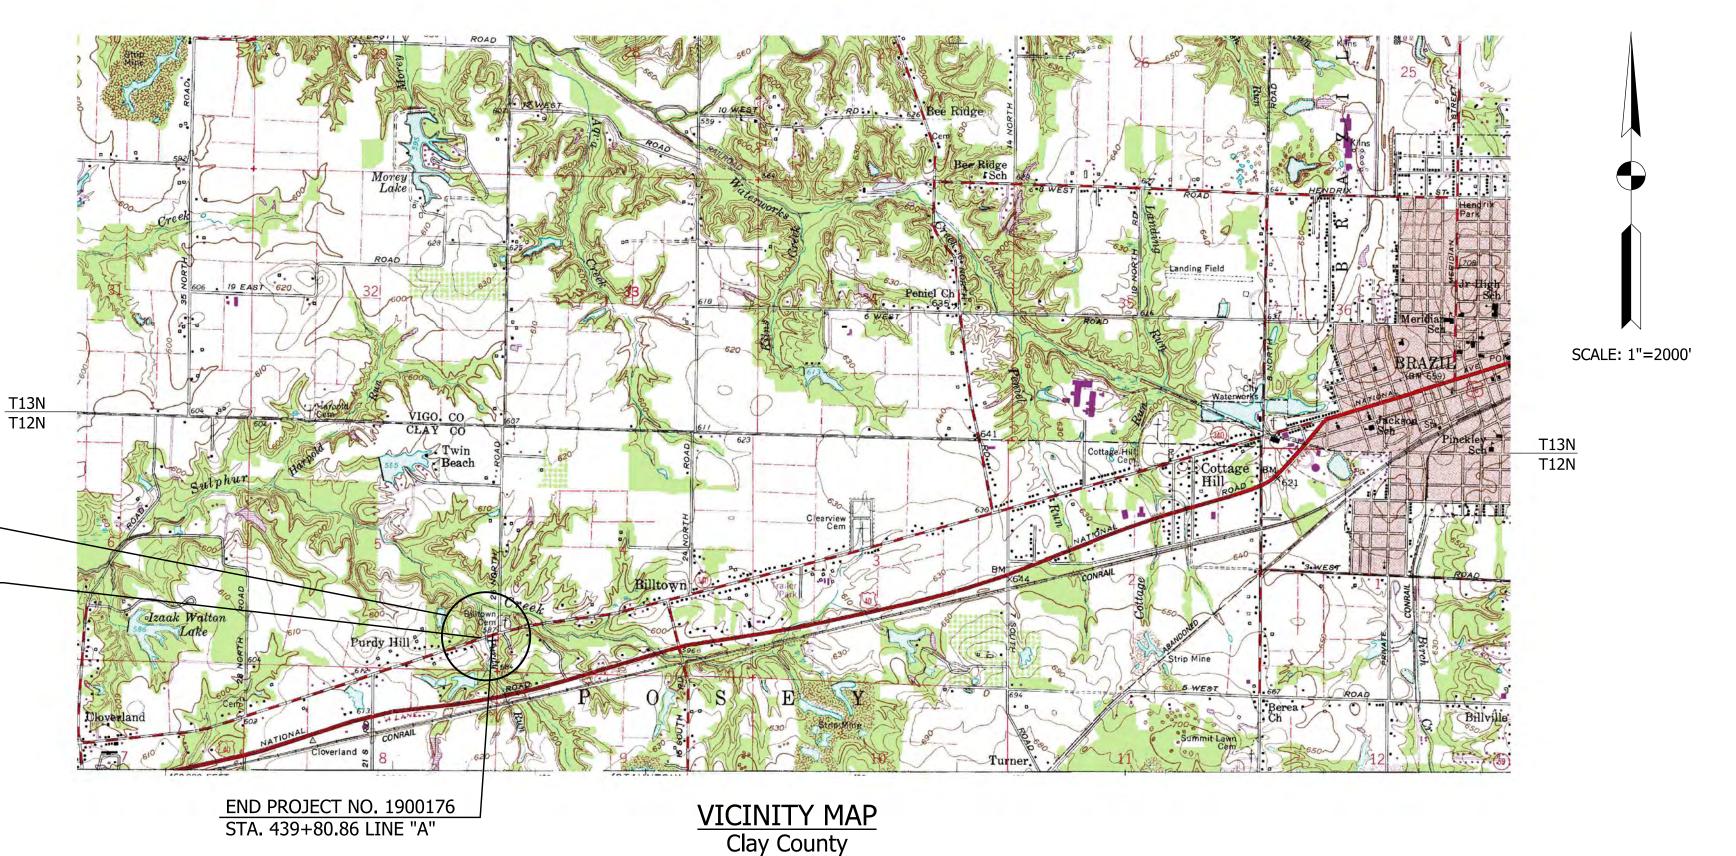

Posey Township

TRAFFIC DATA 1,565 V.P.D. 1,565 V.P.D. D.H.V 167 V.P.H. DIRECTIONAL DISTRIBUTION 55.97 % EB 1.92% A.A.D.T. 1.20% D.H.V. **DESIGN DATA** PROJECT DESIGN CRITERIA 3R (NON-FREEWAY) **FUNCTIONAL CLASSIFICATION** STATE COLLECTOR RURAL/URBAN RURAL LEVEL

ACCESS CONTROL

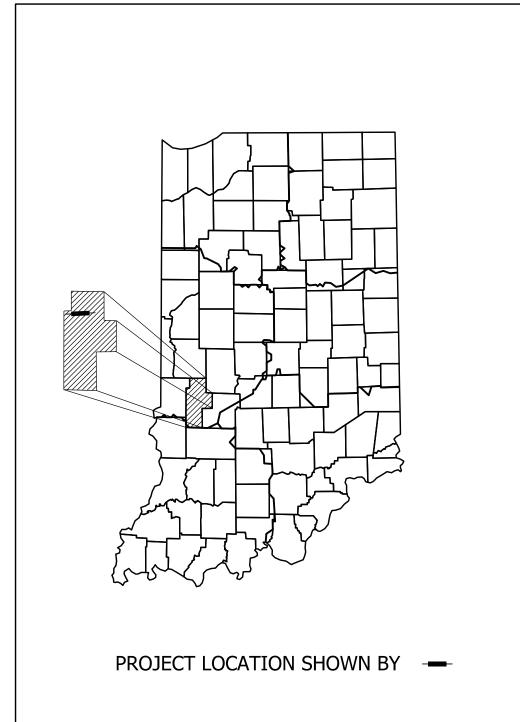

ATITUDE: 39°30'28.08" N	LONGITUDE: 87°12'05.29" W
·	·

BRIDGE LENGTH:	0.008	
ROADWAY LENGTH:	0.029	
TOTAL LENGTH:	0.037	
MAX. GRADE:	-5.20%	

HUC: 05120111030060

INDIANA DEPARTMENT OF TRANSPORTATION STANDARD SPECIFICATIONS DATED 2020 TO BE USED WITH THESE PLANS.

		BRIDGE F	[LE							
	3	340-11-10492								
	С	DESIGNAT.	ION							
	1900176									
SURVEY BOOK		SHEETS								
	1	of	20							
CONTRACT		Γ								
B-42240	B-42240 1900176									

PLANS
PREPARED BY: CHA CONSULTING, INC. (317) 786-0461
PHONE NUMBER

CERTIFIED BY:

APPROVED
FOR LETTING:

INDIANA DEPARTMENT OF TRANSPORTATION

DATE

UTILITIES

ELECTRIC

GAS/PIPELINE Vectren (North) 16000 Allisonville Rd. Duke Energy Cindy Rowland 100 S. Mill Creek Rd. Noblesville, IN 46061 Noblesville, IN 46062 812-491-4765

317-776-5341 publicproject@centerpointenergy.com

cindy.rowland@duke-energy.com

TELECOMMUNICATIONS

New Wave Communications Bart Kotter 102 North 5th St. Vincennes, IN 47591 812-887-8996

bart.kotter@newwavecom.com

Frontier Joe Sarll

8001 West Jefferson Blvd. Fort Wayne, IN 46804 260-461-3324 utilitycordreg@ftr.com

GENERAL NOTES

All earth shoulders, median areas, and cut and fill slopes shall be plain or mulch seeded except where sodding is specified.

This set of plans shall not be construed to be a property replacement survey. Where apparent property lines, owners, or section corner information is shown it is based upon physical evidence or testimony.


The topography information for this project was supplied by CeCon. Attempts have been made to periodically update portions of this project. However, the design consultant does not warrant the accuracy of this data and advises the contractor to field verify all information.


The Vertical Datum Used For The Project Is N.A.V.D. Of 1988. For Additional Information On The Vertical And Horizontal Datums, Refer To The Survey Field Books On File With The INDOT Records Section And Provided To The Contractor Through The Contract Services.

	INDEX									
SHEET NO.	SUBJECT									
1	TITLE									
2	INDEX									
3	TYPICAL CROSS SECTIONS									
4	PLAT NO. 1									
5-6	LOCATION CONTROL ROUTE SURVEY									
7	MAINTENANCE OF TRAFFIC									
8	PLAN AND PROFILE/LAYOUT									
9	TEMPORARY EROSION CONTROL DETAIL									
10-11	GENERAL PLAN									
12-13	MISCELLANEOUS TABLES									
14-19	CROSS SECTIONS									
20	DRIVE PROFILES									

	REVISIONS										
SHEET NO.	DATE	REVISED									

		TNIDTANIA	HORIZONTAL SCALE	BRIDGE FILE				
RECOMMENDED		INDIANA		340-11-10492				
FOR APPROVAL		DEPARTMENT OF TRANSPORTATION	VERTICAL SCALE	DESIGNATION				
	DESIGN ENGINEER DATE			1900176				
DECICALED KAR	DD AMAN DCD		SURVEY BOOK	SHEETS				
DESIGNED: KAB	DRAWN: PCR	TNDEV		2 of 20				
CHECKED. DIA	CHECKED, KAD	INDEX	CONTRACT	PROJECT				
CHECKED: BJA	CHECKED: KAB		B-42240	1900176				

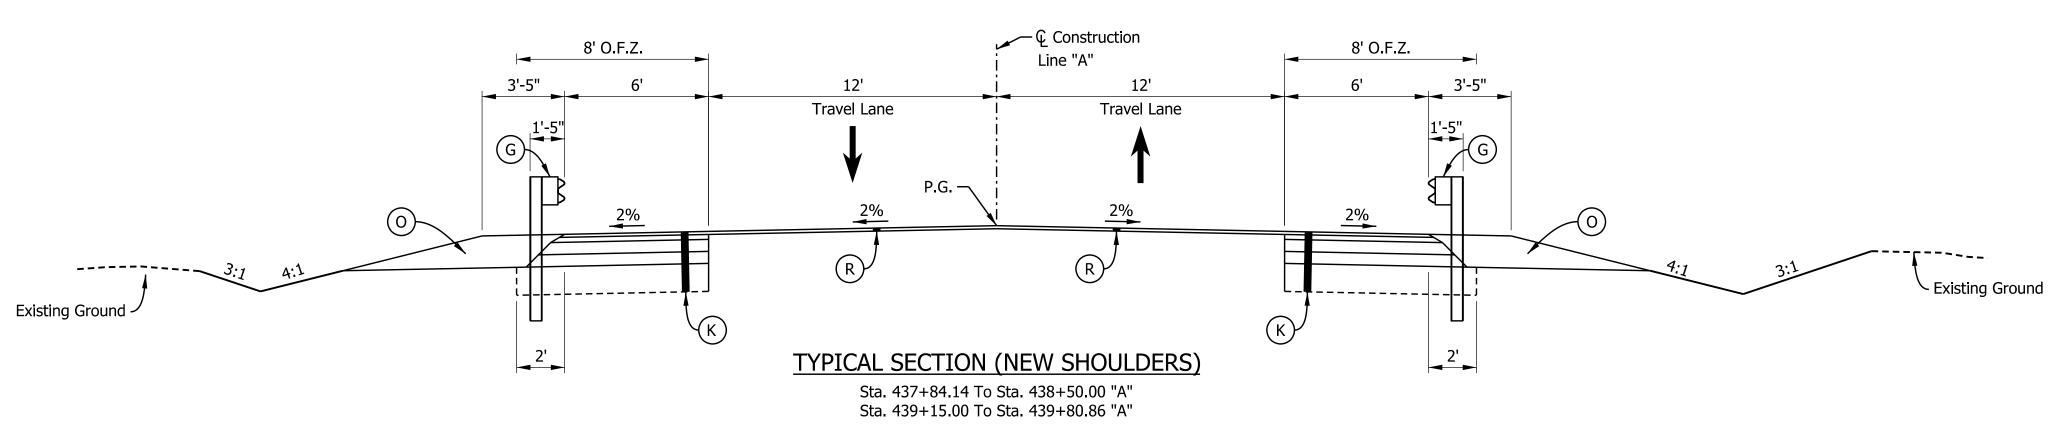

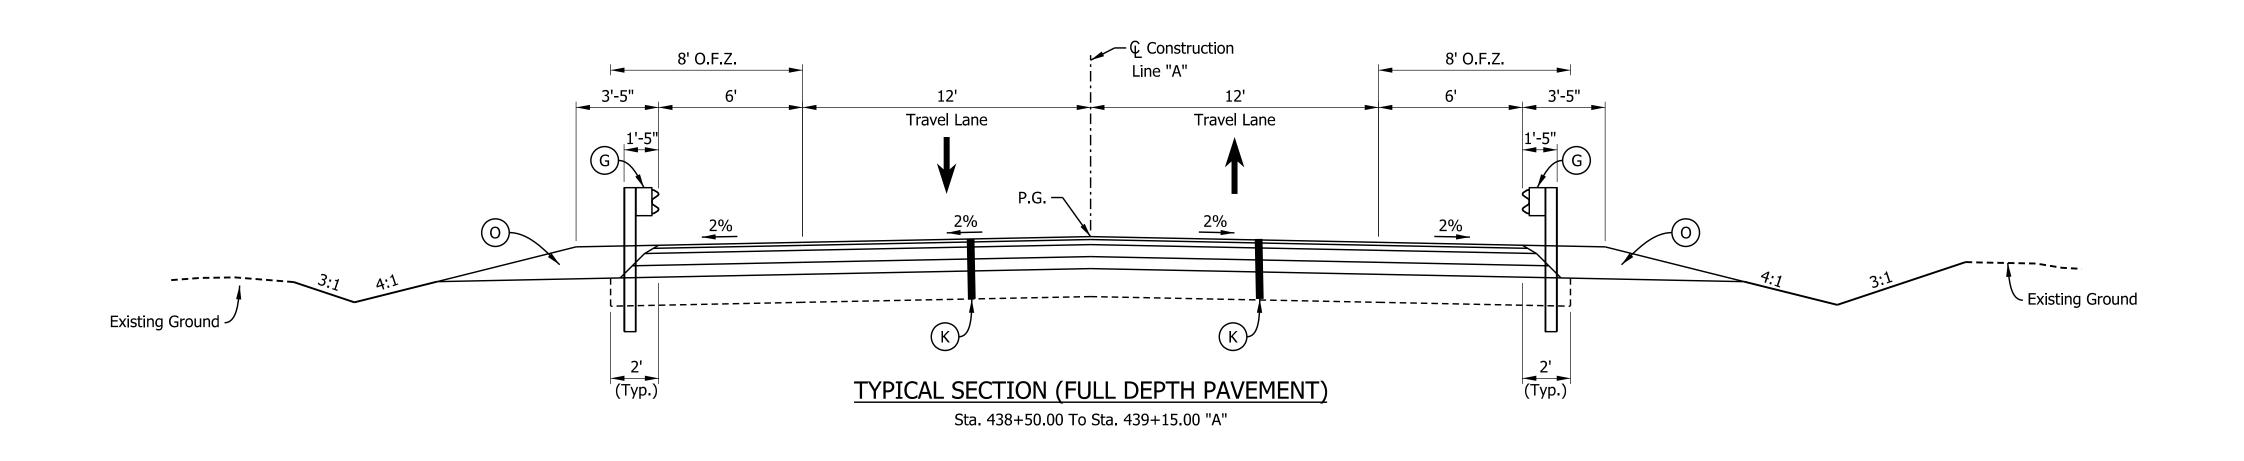

LEGEND

K Full Depth HMA Pavement (Assumed)
165 lbs/sys QC/QA HMA, 3, 64, Surface, 9.5 mm on
275 lbs/sys QC/QA HMA, 3, 64, Intermediate, 19.0 mm on
330 lbs/sys QC/QA HMA, 3, 64, Base, 19.0 mm on
330 lbs/sys QC/QA HMA, 3, 64, Base, 19.0 mm on
(Provide Tack Coat between HMA layers)
Subgrade Treatment, Type IC

R Transition Milling (2" Max.) and Overlay 165 lbs/sys QC/QA HMA, 3, 64, Surface, 9.5 mm on As Required, 275 lbs/sys QC/QA HMA, 3, 64, Intermediate, 19.00 mm

As Required, 275 lbs/sys QC/QA HMA, 3, 64, Intermediate, 19.00 mm

*

O Variable Depth Compacted Aggregate No. 53

G Guardrail, MGS W-Beam

O.F.Z. = Obstruction Free Zone

* = Match Existing

RECOMMENDED FOR APPROVAL

DESIGN ENGINEER


DESIGNED: NAZ

DRAWN: TPH

CHECKED: BJA

CHECKED: NAZ


B-42240

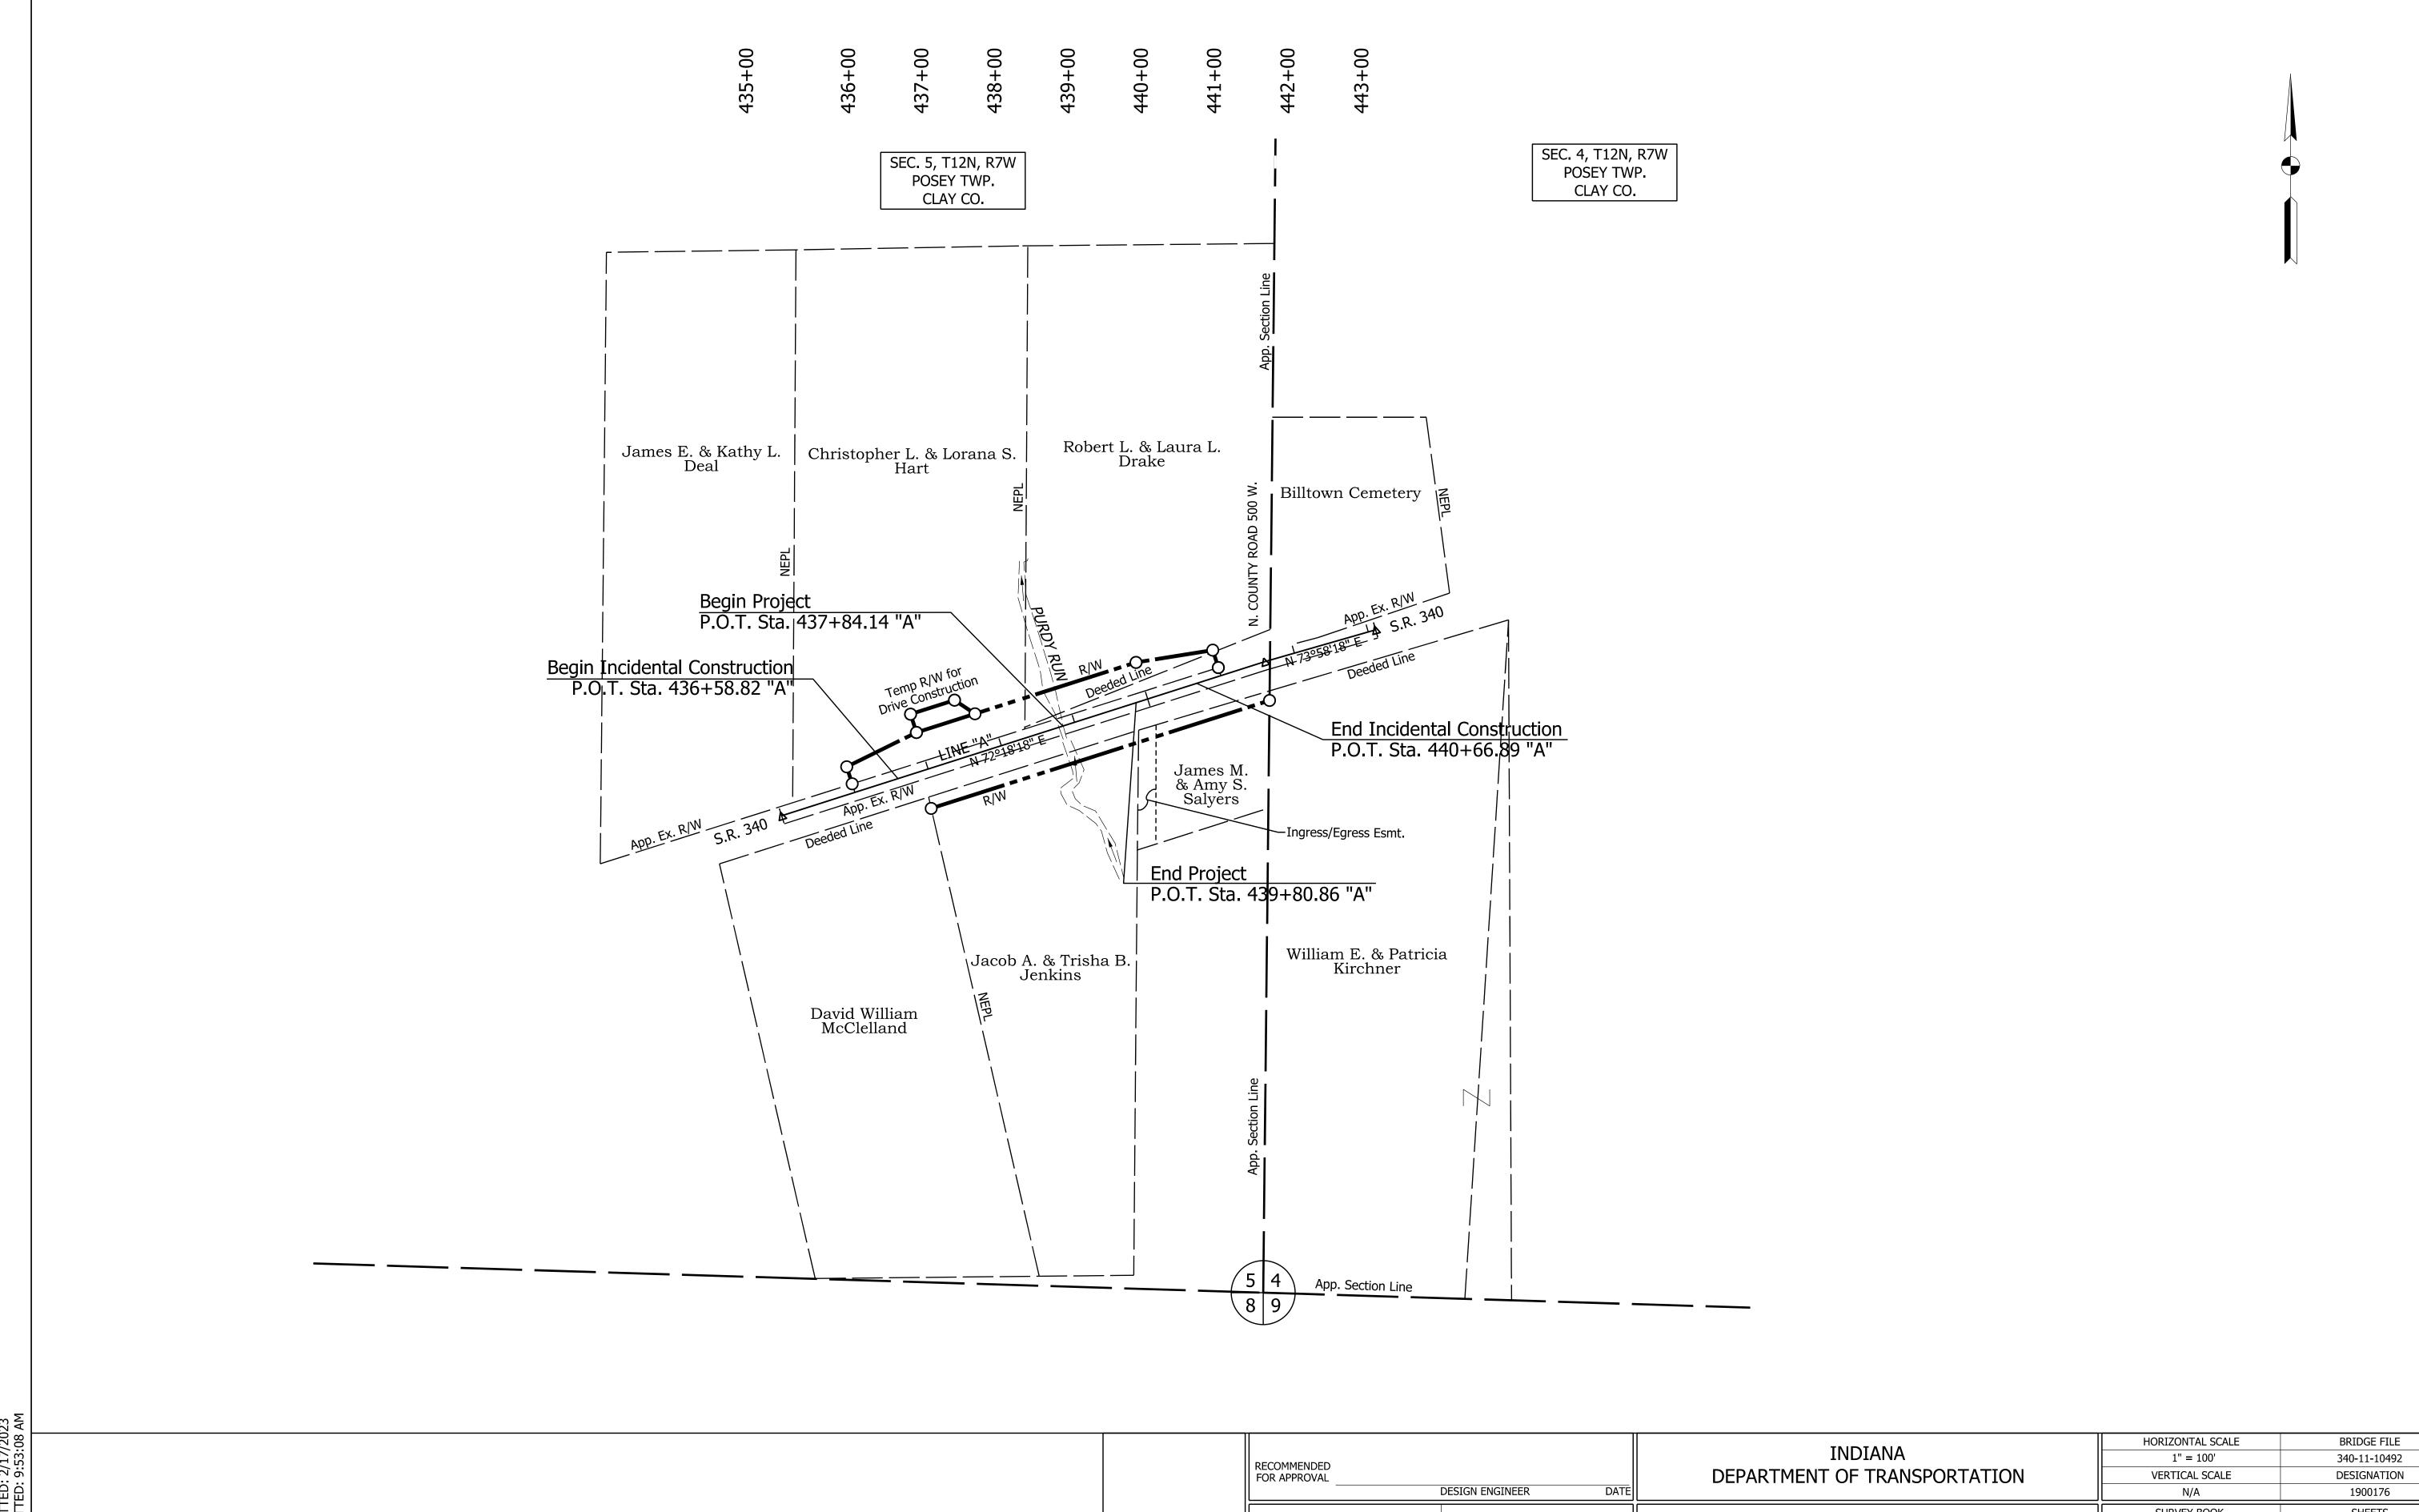

DRAWN: TPH DESIGNED: NAZ CHECKED: NAZ CHECKED: BJA

PLAT NO.1

SURVEY BOOK SHEETS of CONTRACT PROJECT B-42240 1900176

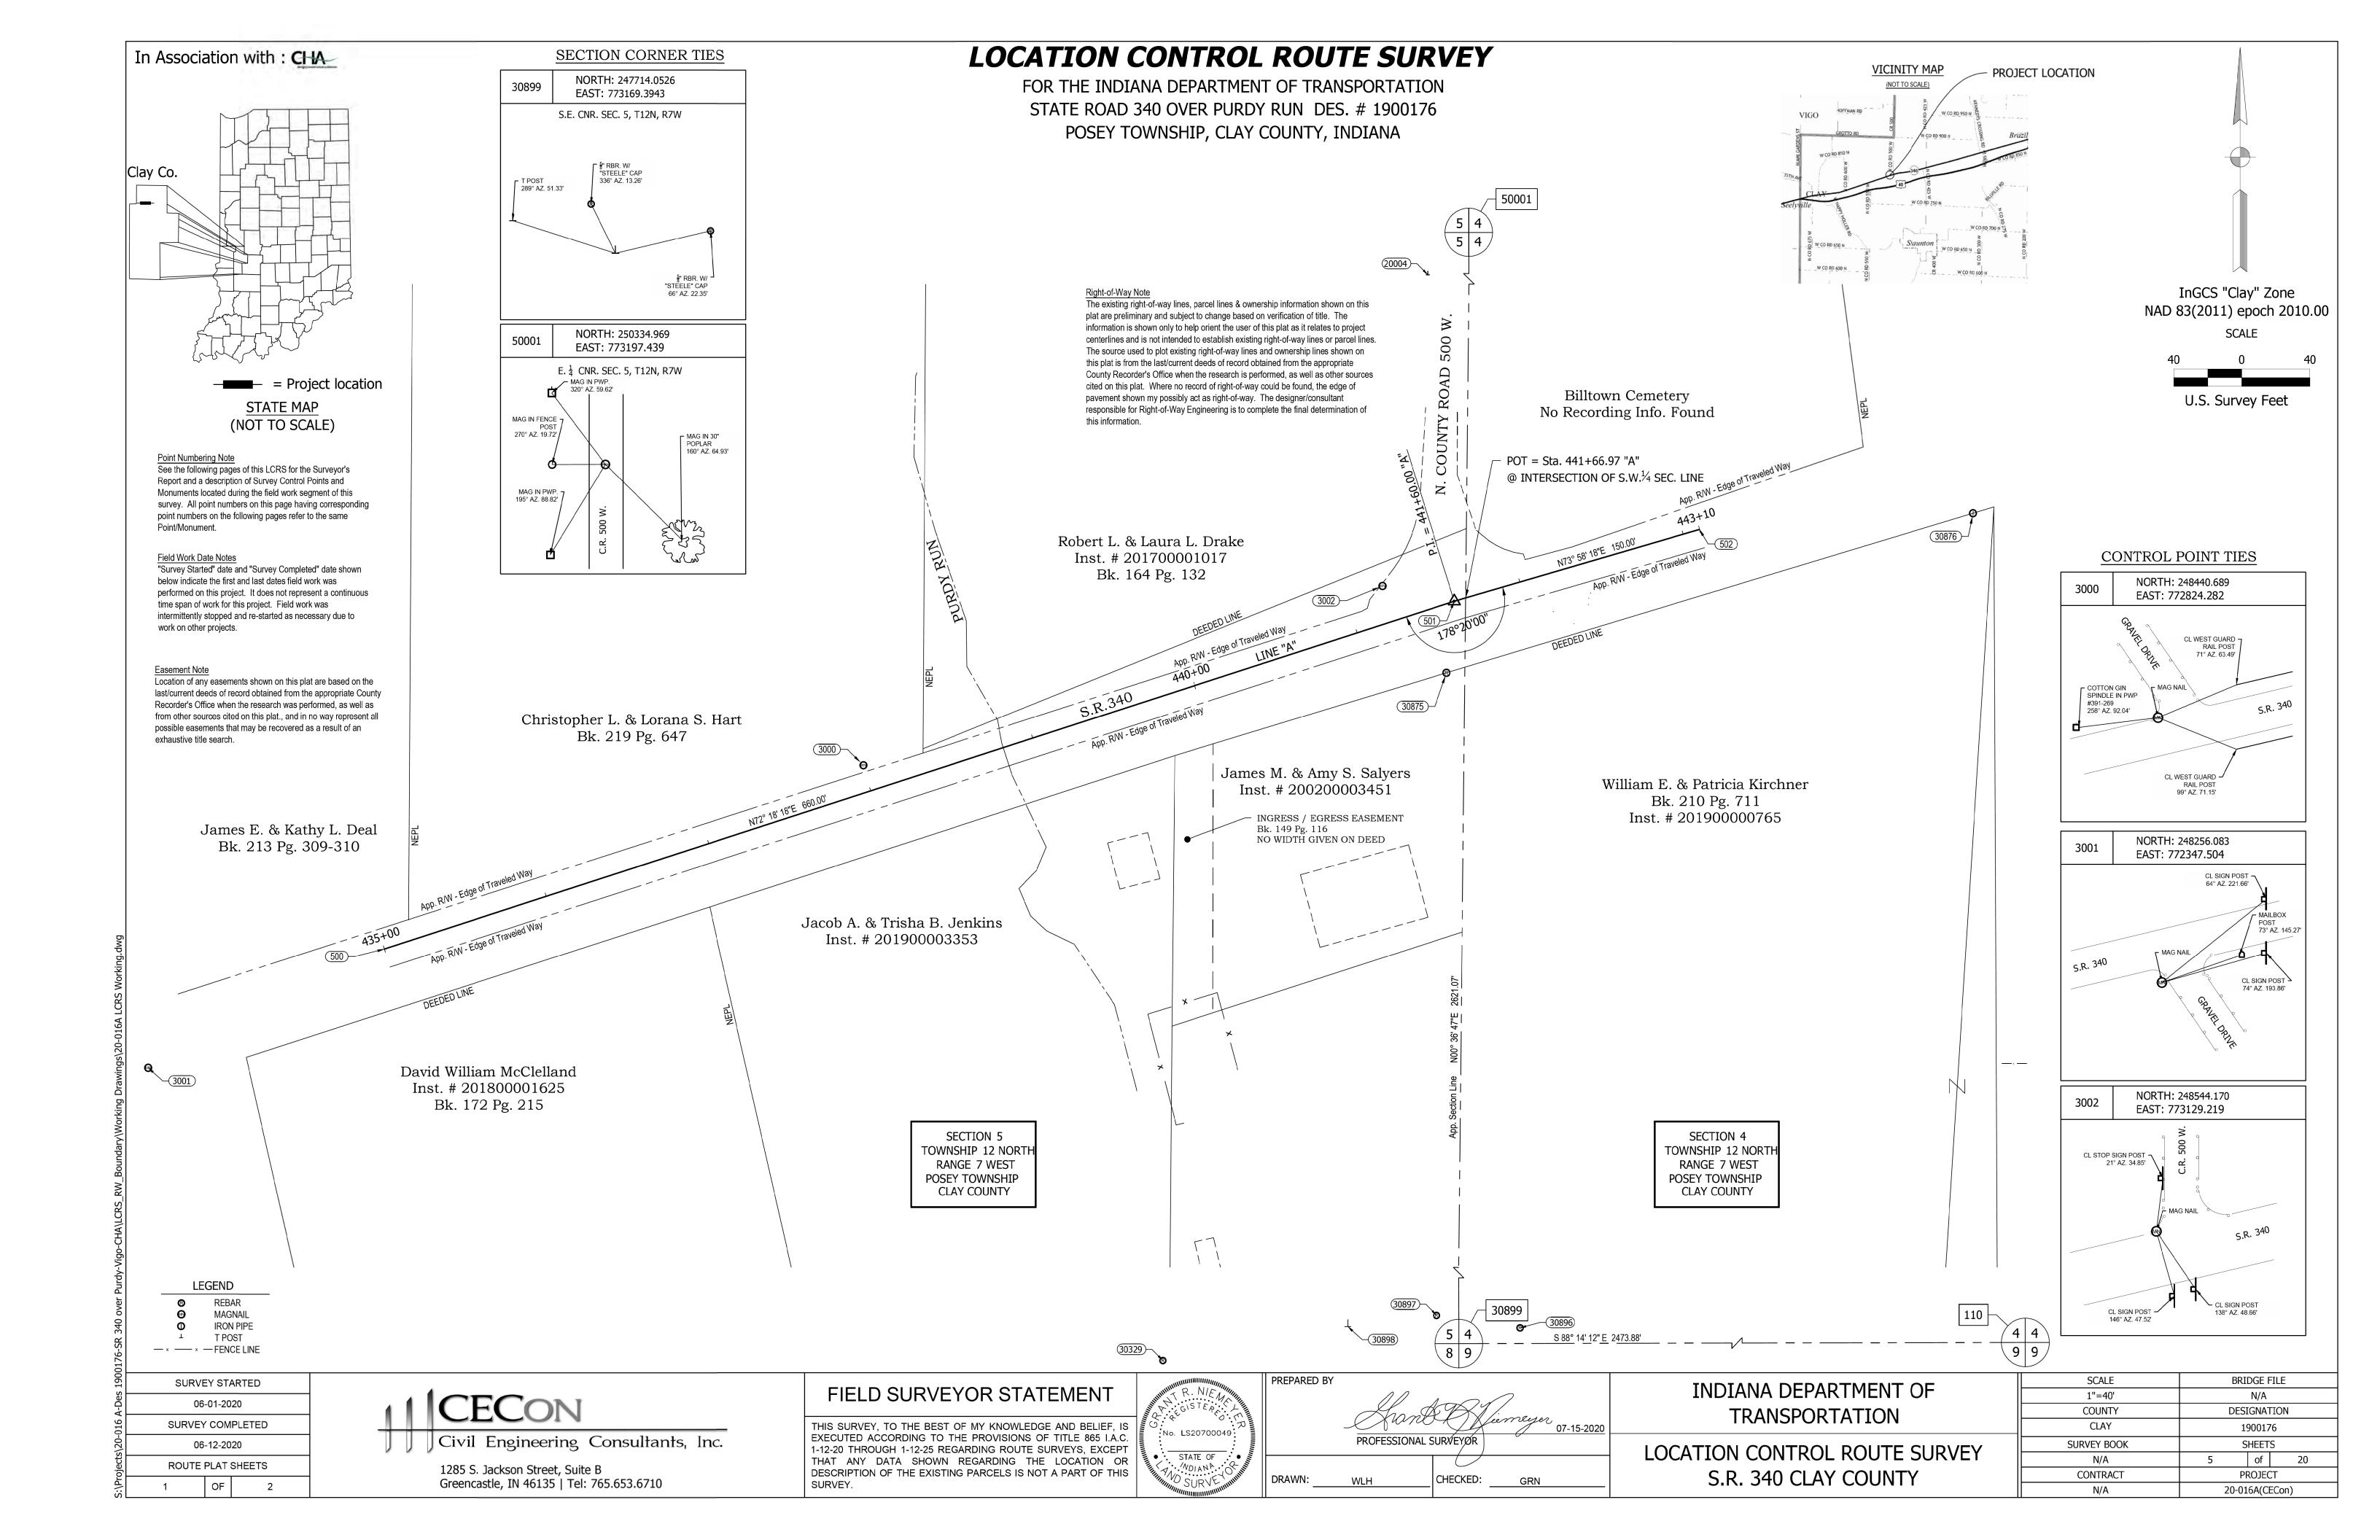

In Association with: CHA

SURVEY REPORT

Intent of Survey:

Civil Engineering Consultants Inc., (hereinafter referred to as CECon) is a sub-consultant, providing Land Surveying Services for CHA Consulting Inc. (Client), these services will be ultimately used for roadway improvements and / or small structure design, for the Indiana Department of Transportation, hereafter referred to as INDOT. The purpose of this survey was to provide the client with a Location Control Route Survey plat (as defined in Title 865 of the Indiana Administrative Code as a "Route Survey"). This survey is NOT to be considered a boundary survey (as defined in Title 865 as an "original survey" or a "retracement survey") and should therefore not be treated as such. This survey will be used for multiple facets of this project, including but not limited to the following: horizontal control, right of way engineering, right of way acquisition, and a basis of alignments for the design engineer. In addition, a design survey (topographic survey) was performed for the client, this survey is intended to be used as a foundation for the design of this project, both for road and bridge improvements.

General Notes:

INDIANA ADMINISTRATIVE CODE: In accordance with Title 865, Article 1, Chapter 12 ("Rule 12") of the Indiana Administrative Code-State Board of Registration for Land Surveyors, the following observations and opinions are submitted regarding the various uncertainties in the locations of the lines and corners established this survey as a result of uncertainties in reference monumentation (both availability and condition); in lines of occupation or possession; In record descriptions and/or plats; and as introduced by random errors in measurement ("Relative Positional Accuracy"). THERE MAY BE UNWRITTEN RIGHTS ASSOCIATED WITH THESE UNCERTAINTIES. The client should assume there is an amount of uncertainty along ANY line or at ANY corner equal in magnitude to the discrepancy in the location of the lines of occupation or possession from the surveyed lines and corners.

As used in this survey, the term "certify" means to state or declare a professional opinion of conditions regarding those facts or findings which are the subject of the certification and does not constitute a warranty or guarantee, either expressed or implied. The surveyor can only certify to those items that are visible and/or things that can be observed, measured, or counted.

Existing monuments recovered and discussed within this report (said points depicted on the plat pages, alignment, and control references and in the coordinate table) represent true and accurate locations as depicted, corresponding with distances and/or azimuths/bearings (if referenced). All control points set were referenced in accordance to Indiana Department of Transportation Design Manual for Location Surveys Part III. Other points recovered but not shown, may be close, but were not within the estimated uncertainty nor did they have any impact on the establishment of lines as shown herein. Secondary control points may have been set for the use in locating or validating other evidence when establishing rights of way or apparent property/boundary lines.

General Description and Location:

CECon Project Number / Description: 20-016 A, S.R. 340 over Purdy Run, Clay County Indiana.

The project is located along S.R. 340 approximately 4.2 miles southwest of the nearest City of Brazil, Indiana. The project scope generally consists of the following Topographic and Route Survey limits, (starting from the center of the existing structure) approximately 400 feet northeasterly and 400 feet southwesterly of subject bridge over Purdy Run, with variable width limits.

Within parts of Sections 4 & 5 Township 12 North, Range 7 West, Posey Township, Clay County, Indiana.

Project Control and Basis of Bearings:

Unless noted otherwise, all bearings, distances, areas, and coordinates shown herein are based upon the Indiana Geospatial Coordinate System's (InGCS) "Clay" zone per NAD 83 (2011) epoch 2010.00 and are reported in U.S. Survey Feet and decimal parts thereof. The zone was developed to minimize the differences between ground-measured horizontal distances and the corresponding grid coordinate (map) distances within the counties bearing these zone names.

The InGCS "Clay" zone coordinates and associated metadata are listed to facilitate a seamless workflow between various geospatial industries (surveying, civil engineering, construction, environmental, GIS, etc.), to provide a means by which to enable the re-establishment of the survey lines, i.e. alignments (should any monuments on them be destroyed), and to provide a mechanism for the perpetuation of any boundary corner monuments included in this survey, e.g., USPLS, Grant, Donations, local subdivisions and/or tracts. To preserve the relative positional relationships of these surveyed lines and/or boundary corner monuments in future surveying, construction, maintenance, etc. activities, it is recommended to utilize the positions associated with the physical "Survey Network Control Points" listed in the "Reported Project Points Metadata Table" that were set and/or found during this survey.

Metadata:

InGCS "Clay" Zone Parameters Geometric Datum: NAD 83(2011) epoch 2010.00 Projection Type: Transverse Mercator Central Meridian: 87°09'00" west longitude Central Meridian scale factor: 1.000024 Latitude of Grid Origin: 39°09'00" north latitude False Northing: 36,000.000 m (118,110.00 U.S.Ft) False Easting: 240,000.000 m (787,400.00 U.S.Ft)

Control verification:

NGS Control Point Check-in <u>Designation - Prairie City</u> PID - KA1790

Published Coordinates (InGCS) Observed Coordinates <u>Delta(Δ) Value</u> Northing: 225,952.7266 U.S. Ft. Northing: 225,952.7369 U.S. Ft. +0.0103'

Easting: 794,200.2397 U.S. Ft. Easting: 794,200.2116 U.S. Ft. -0.0281'

This monument is verified utilizing the INDOT Continuously Operating Reference Station (INCORS) a real-time kinematic (RTK) correction service over the internet. This system is stated by INDOT as "Providing Network RTK in RTCM (Real Time Correction Message) 2.3, and 3.1 in the MAX (R2K2 Full) and i-MAX (R2K2 LITE) formats via NTRIP (Networked Transport of RTCM via Internet) and TCP/IP, as well as CMR and CMR+ in the MAX (R2K2 Full) and i-MAX (R2K2 LITE) formats via

Field Work Date Notes "Survey Started" date and "Survey Completed" date shown below indicate the first and last dates field work was performed on this project. It does not represent a continuous time span of work for this project. Field work was intermittently stopped and re-started as necessary due to work on other projects.

190	SURVE	EY STA	ARTED									
Projects\20-016 A-Des	6-1-2020											
	SURVEY COMPLETED											
\$\20-	6-12-2020											
ojects	ROUTE PLAT SHEETS											
Pro	2	OF	2									



Greencastle, IN 46135 | Tel: 765.653.6710

FIELD SURVEYOR STATEMENT

THIS SURVEY, TO THE BEST OF MY KNOWLEDGE AND BELIEF, IS EXECUTED ACCORDING TO THE PROVISIONS OF TITLE 865 I.A.C. 1-12-20 THROUGH 1-12-25 REGARDING ROUTE SURVEYS, EXCEPT THAT ANY DATA SHOWN REGARDING THE LOCATION OR DESCRIPTION OF THE EXISTING PARCELS IS NOT A PART OF THIS SURVEY.

GEOMETRIC DATUM: NAD83(2011) EPOCH 2010.00

110

500

501

502

3001

3002

20004

30329

30875

30876


30896

30897


30898

30899

50001

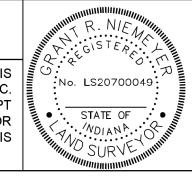

DRAWN:

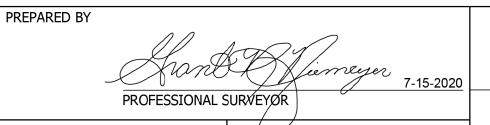

CHECKED:

INDIANA DEPARTMENT OF **TRANSPORTATION**

LOCATION CONTROL ROUTE SURVEY S.R. 340 CLAY COUNTY

BRIDGE FILE SCALE N/A N/A COUNTY DESIGNATION CLAY 1900176 SURVEY BOOK SHEETS N/A of 20 CONTRACT PROJECT N/A 20-016A(CECon)

LINEAR UNITS: U.S. SURVEY FEET

FOUND/SET/CALC'D (NOT

Reference Plans / Surveys: • State of Indiana Bridge Plans Project: No. F.A. No. 6 Section: A dated August 11, 1919, Station 438+82. Hereinafter referred to as the "1919 Plans".

- State of Indiana Highway Plans Project: No. 6 Section: A, National Old Trails Road dated 1919, Stations 218+66 to 607+81. Hereinafter referred to as the "Road
- Route Survey Plat for the Indiana Department of Transportation recorded in the Clay County Recorder's Office on May 14, 2002 as Instrument # 200200003089, Book 32 Page 1381. Hereinafter referred to as the "2002 Plat".
- State of Indiana Highway Plans Project, Project No. STP 5284 (011) Code 4228, Des. No. 9801810, dated September 24th, 2003.
- Parcel Plat for Gary Jenkins recorded in the Clay County Recorder's Office on March 22, 2009 as Instrument # 201900000765, Book 178 Page 922.
- Cash, Waggner and Associates, Survey Recorded March 3rd, 2019 as Instrument Number 201900000765.

Boundary Lines / Lines of Possession / Right of Way Notes:

Regarding "lines of occupation or possession" in the above section, this term refers to lines which are marked by visible, obvious, well-defined and maintained, man-made or placed objects or limits, such as, but not limited to fences, hedges, mow lines, field-divide lines, woods lines, retaining walls, etc. The uncertainty cited for a line of occupation is general in nature and in not intended to be specific for every point along the line. Therefore, portions of the occupation lines may vary from the surveyed lines by distances greater or less than the uncertainty cited in this report or shown on the plat of survey.

The existing right of way lines, parcel ownership lines, and ownership information shown on this plat are preliminary and subject to change based on verification/validation of title. The within plat and survey were prepared without benefit of current evidence of source of title (title work) for the area and are therefore subject to any statement of facts revealed by examination of such documents. This information is shown only to help orient the user of this plat as it relates to project centerlines and is not intended to establish existing right of way lines or ownership lines. The source used to plot existing right of way lines and ownership lines shown on this plat is from the last/current deeds of record obtained from the appropriate County Recorder's Office or other state agencies when the research was performed, as well as from other sources cited on this plat. Where no record right of way could be found, the edge of pavement shown may possibly act as an easement by prescription. The designer/consultant responsible for Right of Way Engineering is to complete the final determination of this information. It is always presumed that there are rights associated to all areas where right of way monuments or possession exist; however, documentation is not always provided to show the extent of those rights. No title search or encumbrance report was performed for this project.

Any depiction of possible intrusion, trespass, invasion, and/or possible encroachment into the possessions or rights of another is not a matter of this survey. An attorney and/or title company should be consulted in all matters with respect to any rights of possession, matters of title, and all things with respect to any encumbrances if depicted on this survey.

"Apparent R/W-Edge of traveled way": As reflected / labeled herein, the apparent right of way lines is based on the existing edge of the traveled way. INDOT Right of way grants, was recovered and reviewed. The grants appear to be signed circa 1938, but were recorded in July of 1974, and are deemed invalid. Therefore, the existing edge of traveled way is used as the road boundary for this survey.

<u>United States Public Land Survey System (USPLSS) and Monuments Found:</u>

The recovery of the corners within Section 4 and 5 Township 12 North, Range 7 West are worthy of mention and are discussed as follows:

Point No. 30899: a "T"-post is found to be representing the apparent common corner of the southeast corner Section 5, southwest corner of Section 4, northeast corner of Section 8 and the northwest corner of Section 9. In addition, this point was verified as being point (4), as reflected on a survey performed by Cash, Waggner and Associates, recorded March 3rd, 2019 as Instrument Number 201900000765, in the office of the Clay County Recorder's office. This point is No reference ties were provided by the Clay County Surveyor for this point. However, new ties (via CECon Survey) for this point are shown herein for future reference.

Point No. 50001: a "PK-nail" found to be flush with surface, representing the apparent common corner of the northwest corner of the southwest quarter Section 4. This point was verified as being point (5), as reflected on a survey performed by Cash, Waggner and Associates, recorded March 3rd, 2019 as Instrument Number 201900000765, in the office of the Clay County Recorder's office. In addition, survey ties were verified with using the "2002 Plat" as performed by INDOT. See plat herein for verified referenced ties for this point.

Point No. 30898: a "U"-post was found 1.5 ft above grade in good condition. This post is found to be approximately 49 feet westerly of point 30899 (southwest corner of Section 4). This point (30899) was located as being the southwest corner of Section 4, per the INDOT "2002 Plat", however, the undersigned disagrees with this location, upon further review and field investigations this point was not used as representing the southwest corner of Section 4.

Point No. 110: A calculated position based on the INDOT "2002 Plat", representing the southeast corner of the southwest quarter of Section 4.

Alignments:

Line "A" - Is an alignment that was re-constructed from utilizing the "Road Plans". Line "A" is re-established, based on the existing bridge location, and rotating the line to a best fit of the concrete. Point 500, P.I. Station 441+60.00 LN. "A" REV. = 441+60 Project FA 6, 1919, was calculated based on the existing configuration of the pavement (intersecting tangent lines). Originally this P.I. Station was intended to be on the quarter section line along the west line of the southwest quarter, according to the INDOT "2002 Plat" as mentioned above, however, with agreeing and accepting the location of the Cash, Waggner and Associates surveys location, the west line moved east approximately 7 feet east and is now intersecting Line "A" at P.O.T. Station 441+66.97.

The alignment was not staked in the field; control and section corners are mathematically relative (station / offset) to the alignment and will be shown with stations and offsets and coordinate values as needed herein. Line "A" can be re-generated / staked in the field, if required or needed once construction is completed, by

Easements and Regulated Drainage Note:

All county maintained regulated drains (open or otherwise) have an easement associated with said drain, determined only by the County Drainage Board and/or County Surveyor, unless otherwise dedicated, recorded, and/or accepted by statute.

Certificate of Survey:

This survey, to the best of my knowledge and belief, is executed per the provision of Title 865 I.A.C. 1-12-20 through 1-12-25 regarding route surveys, except that any data shown regarding the location or description of the existing parcels is not a part of this survey. Data and information were collected from June 1, 2020 through June 12, 2020. The data collected, was gathered using electronic total stations applying standard radial surveying techniques and by global positioning equipment, utilizing the INDOT Continuously Operating Reference Station (INCORS).

The Relative Positional Accuracy (due to random errors in measurement) of the corners and monuments found and set established during this survey is within the specification for an Urban Survey (+/- 0.07 feet + 50 parts per million) as defined in I.A.C. 865.

Ownership information:

Ownership information indicated hereon is identified in County or Township records. The within plat and survey were prepared without benefit of current evidence of source of title (title work) for the area and are therefore subject to any statement of facts revealed by examination of such documents.


Redact Statement:

I affirm, under the penalties of perjury, that I have taken reasonable care to redact each Social Security Number in this document, unless required by law. By Grant R. Niemeyer

ABOVE/FLUSH/BELOW **NORTH LATITUDE** WEST LONGITUDE **EASTING** STATION OFFSET MONUMENT TYPE NORTHING LINE PURPOSE SET) GRADE 87°11'30.005106" SOUTH 1/4 CNR. SEC. 12,T12N,7W N/A CALC'D N/A 247637.9250 775642.1058 39°30'20.130222" N/A 87°12'09.551531" 435+00.00 CALC'D N/A 248334.7648 772542.7330 39°30'27.001011" 0.00' P.O.T. 435+00.00 LINE "A" 773171.5075 N/A N/A 248535.3706 39°30'28.987142" 87°12'01.530956" 441+60.00 0.00' P.I. 441+60.00 LINE "A" CALC'D Α N/A 248576.7873 773315.6763 39°30'29.397255" 87°11'59.691905" 443+10.00 0.00' N/A CALC'D Α P.O.T. 443+10.00 LINE "A" MAGNAIL W/ "CECON CONTROL" TAG 248440.6889 772824.2821 39°30'28.049464" 87°12'05.960256" 438+00.42 15.34' Lt. SURVEY NETWORK CONTROL POINT SET **FLUSH** 248256.0834 772347.5042 39°30'26.222272" 87°12'12.041698" SURVEY NETWORK CONTROL POINT MAGNAIL W/ "CECON CONTROL" TAG SET **FLUSH** 773129.2193 39°30'29.073875" 87°12'02.070542" 441+22.39 21.24' Lt. MAGNAIL W/ "CECON CONTROL" TAG SET FLUSH 248544.1703 SURVEY NETWORK CONTROL POINT 249102.9560 773160.8860 39°30'34.596496" 87°12'01.670525" 443+06.51 548.45' Lt. FOUND Α PROPERTY EVIDENCE T POST 48" A.G. 247757.6197 773005.1538 39°30'21.299749" 87°12'03.647720" 437+65.12 690.39' Rt. 5/8" REBAR NO CAP **FOUND FLUSH** PROPERTY CORNER Α 5/8" REBAR W/ "WILLIAM STEELE" CAP 248494.1403 773166.8973 39°30'28.579640" 87°12'01.589479" 441+43.08 37.88' Rt. PROPERTY CORNER FOUND FLUSH 773476.5034 **FOUND** 248586.0959 39°30'29.490127' 87°11'57.640091' PROPERTY CORNER 1/2" IRON PIPE FLUSH 5/8" REBAR W/ "WILLIAM STEELE" CAP 773189.8925 87°12'01.290600" 439+30.58 779.56' Rt. FLUSH 247722.9609 39°30'20.958245" PROPERTY EVIDENCE FOUND 5/8" REBAR W/ "WILLIAM STEELE" CAP 247726.1701 773164.0108 39°30'20.989819" 87°12'01.620817" 439+06.90 768.64' Rt. **FOUND** PROPERTY EVIDENCE FLUSH 773120.7271 39°30'21.031227" 87°12'02.173055" 751.47' Rt. 247730.3843 438+66.95 PROPERTY EVIDENCE STEEL T POST **FOUND** 48" A.G. Α 781.82' Rt. 247714.0526 773169.3943 39°30'20.870092" 87°12'01.552049" S.E. CORNER, SEC.5,T12N,R7W T POST 439+08.35 **FOUND FLUSH** 250334.9690 773197.4390 39°30'46.772603" 87°12'01.212948" EAST 1/4 CNR. SEC. 5, T12N, R7W PK NAIL **FOUND** FLUSH

REPORTED PROJECT POINTS METADATA TABLE

GRID SYSTEM-ZONE: InGCS - Clay

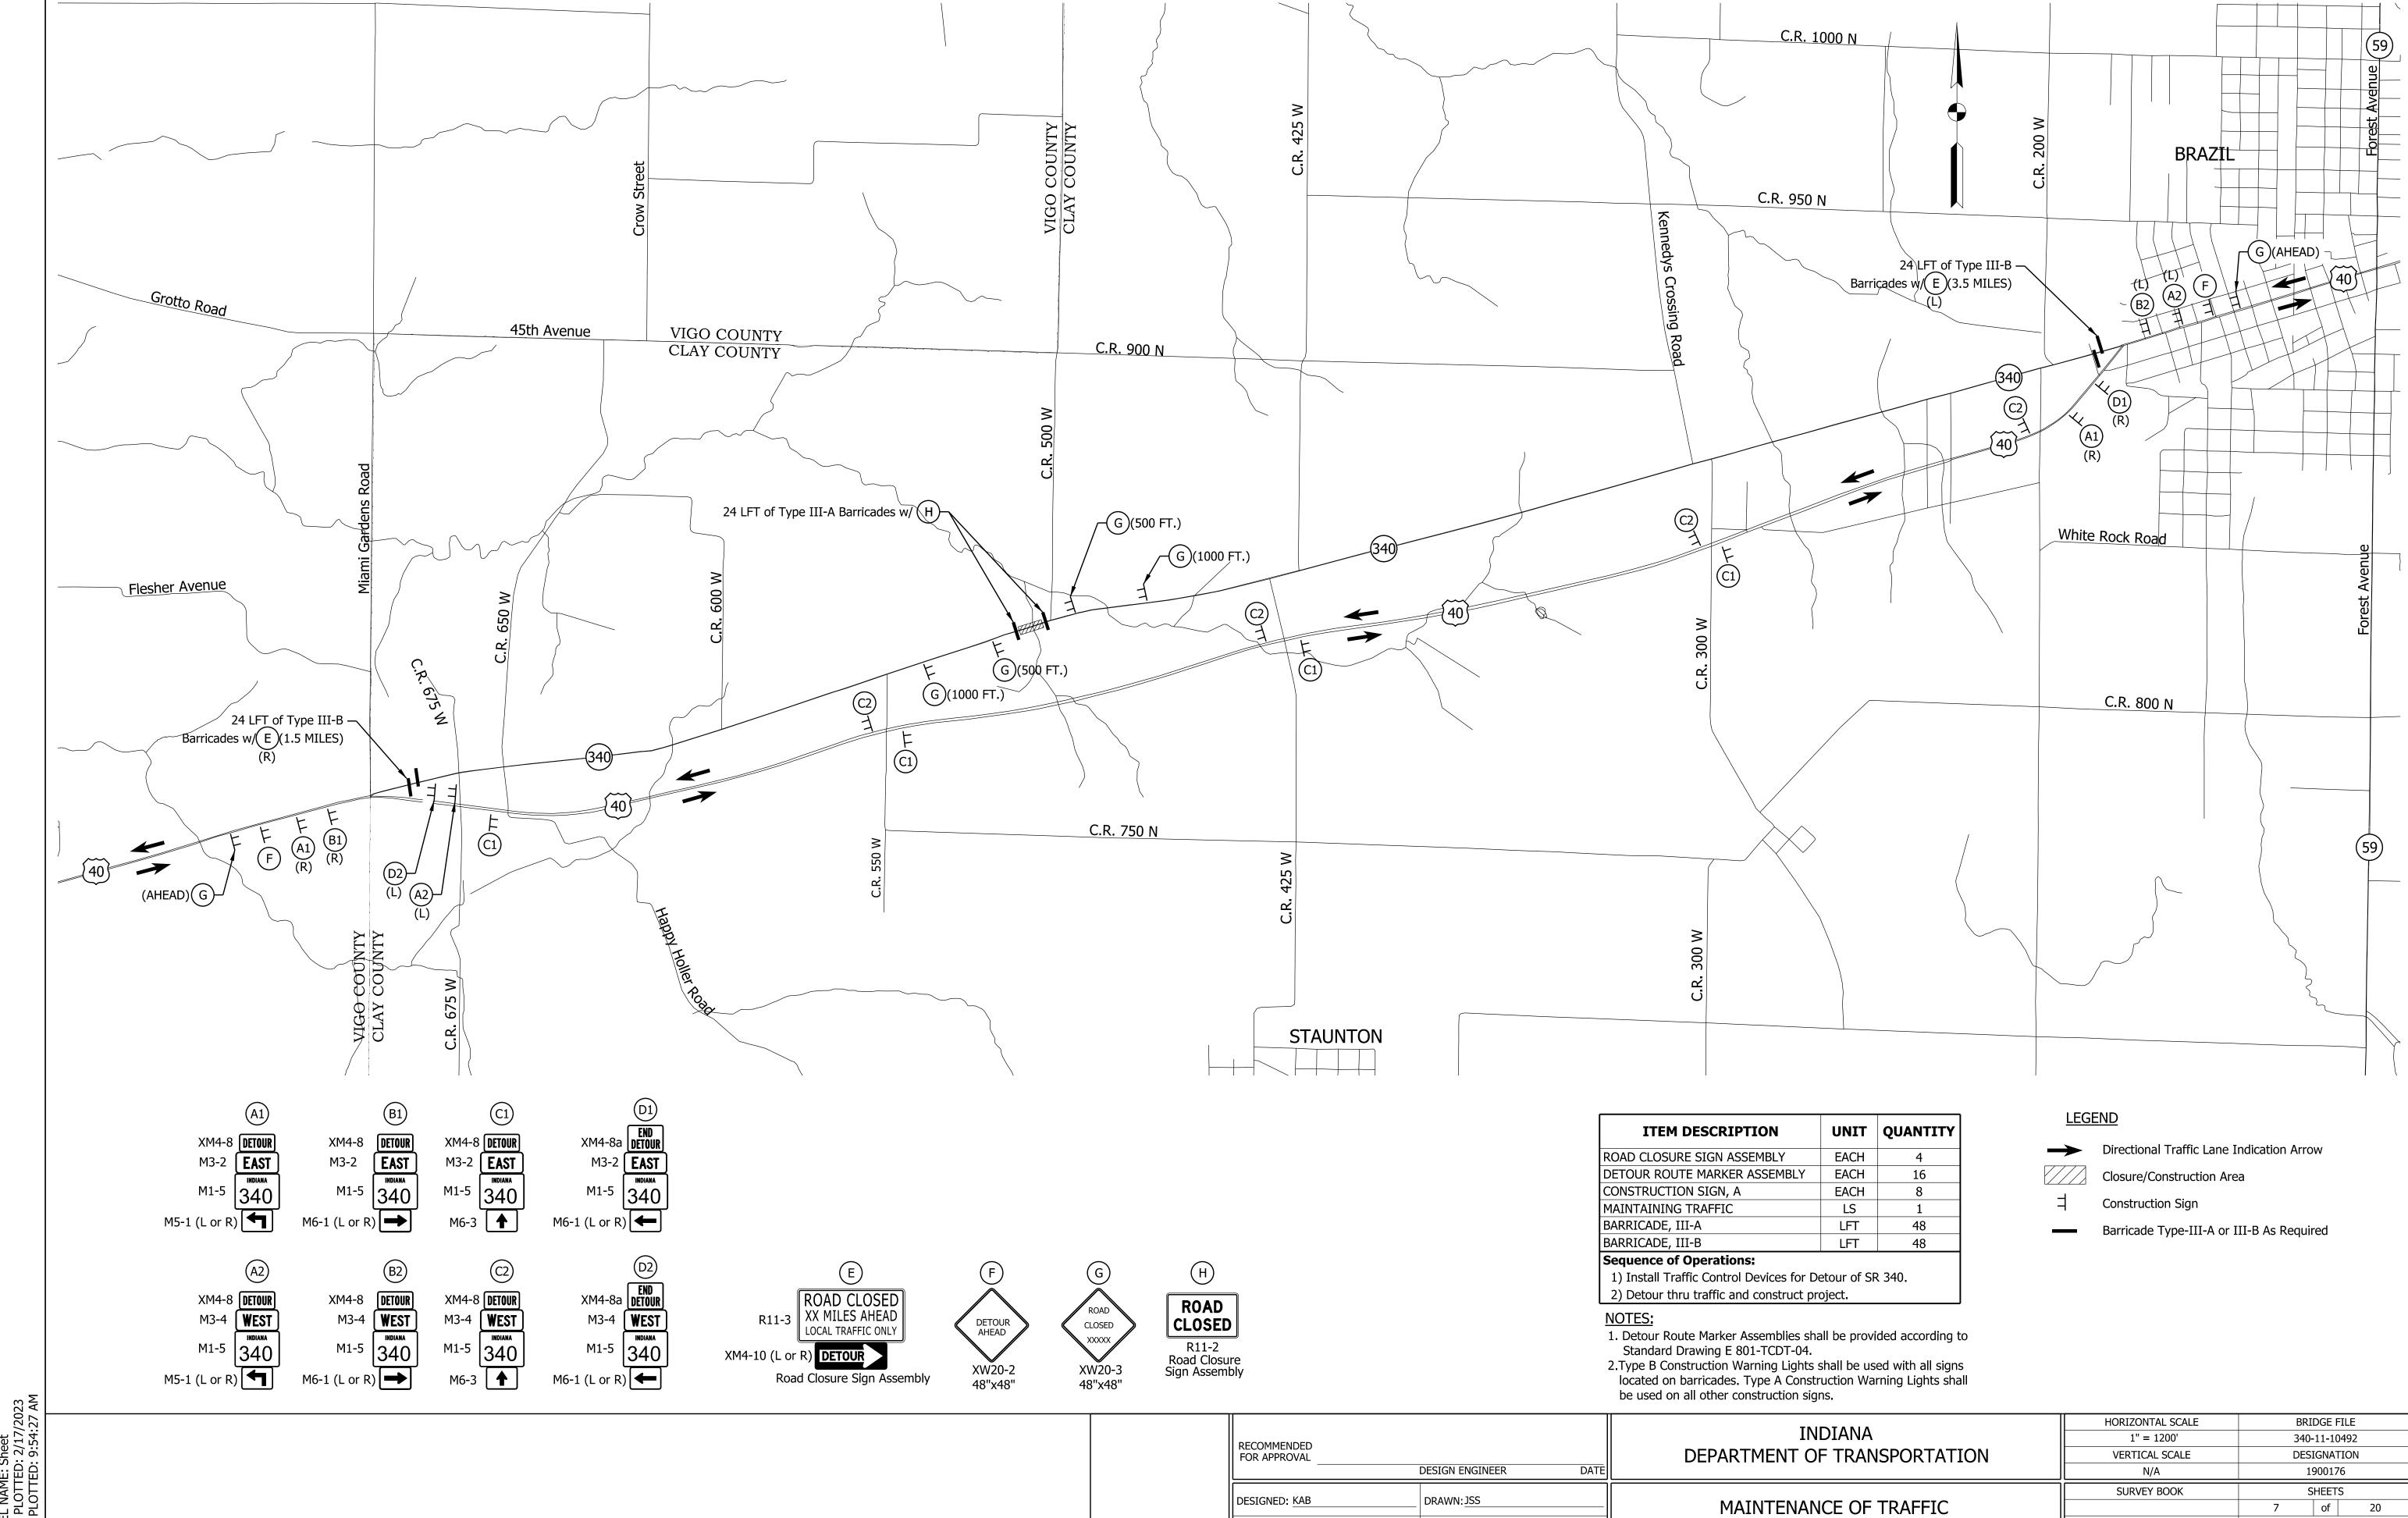

CHECKED: NAZ

CHECKED: KAB


DETOUR ROUTE


PROJECT

1900176

CONTRACT

B-42240

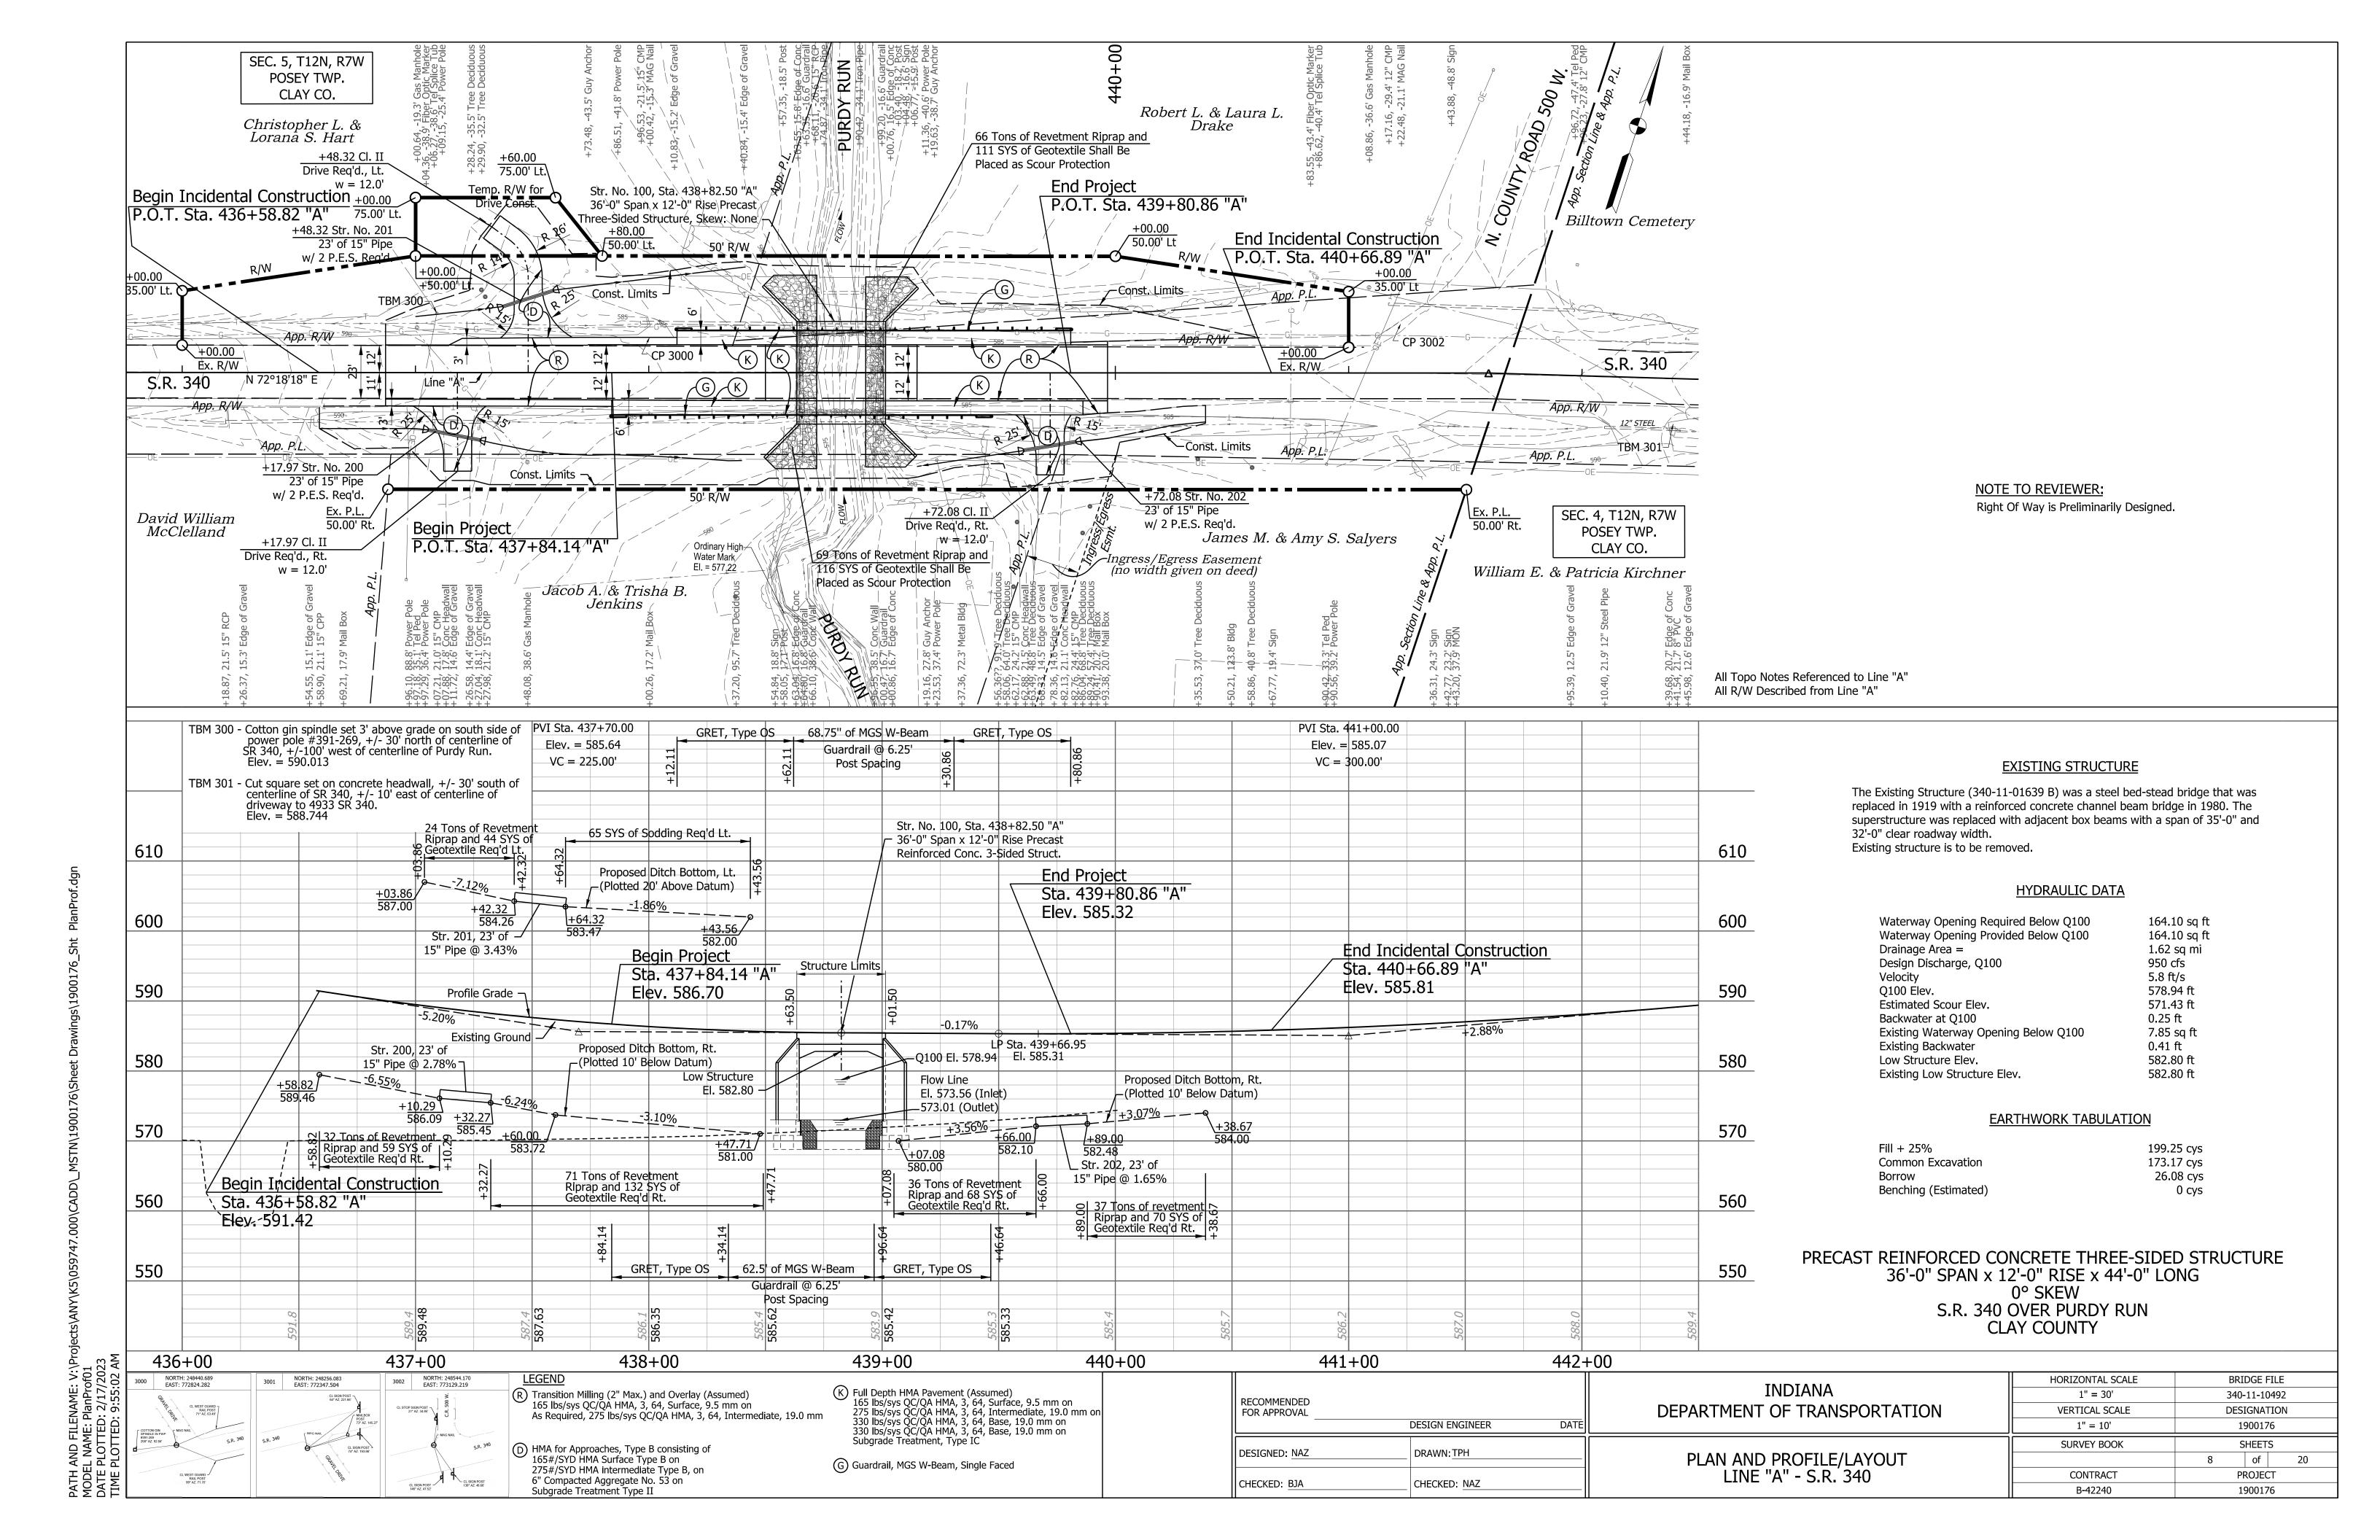

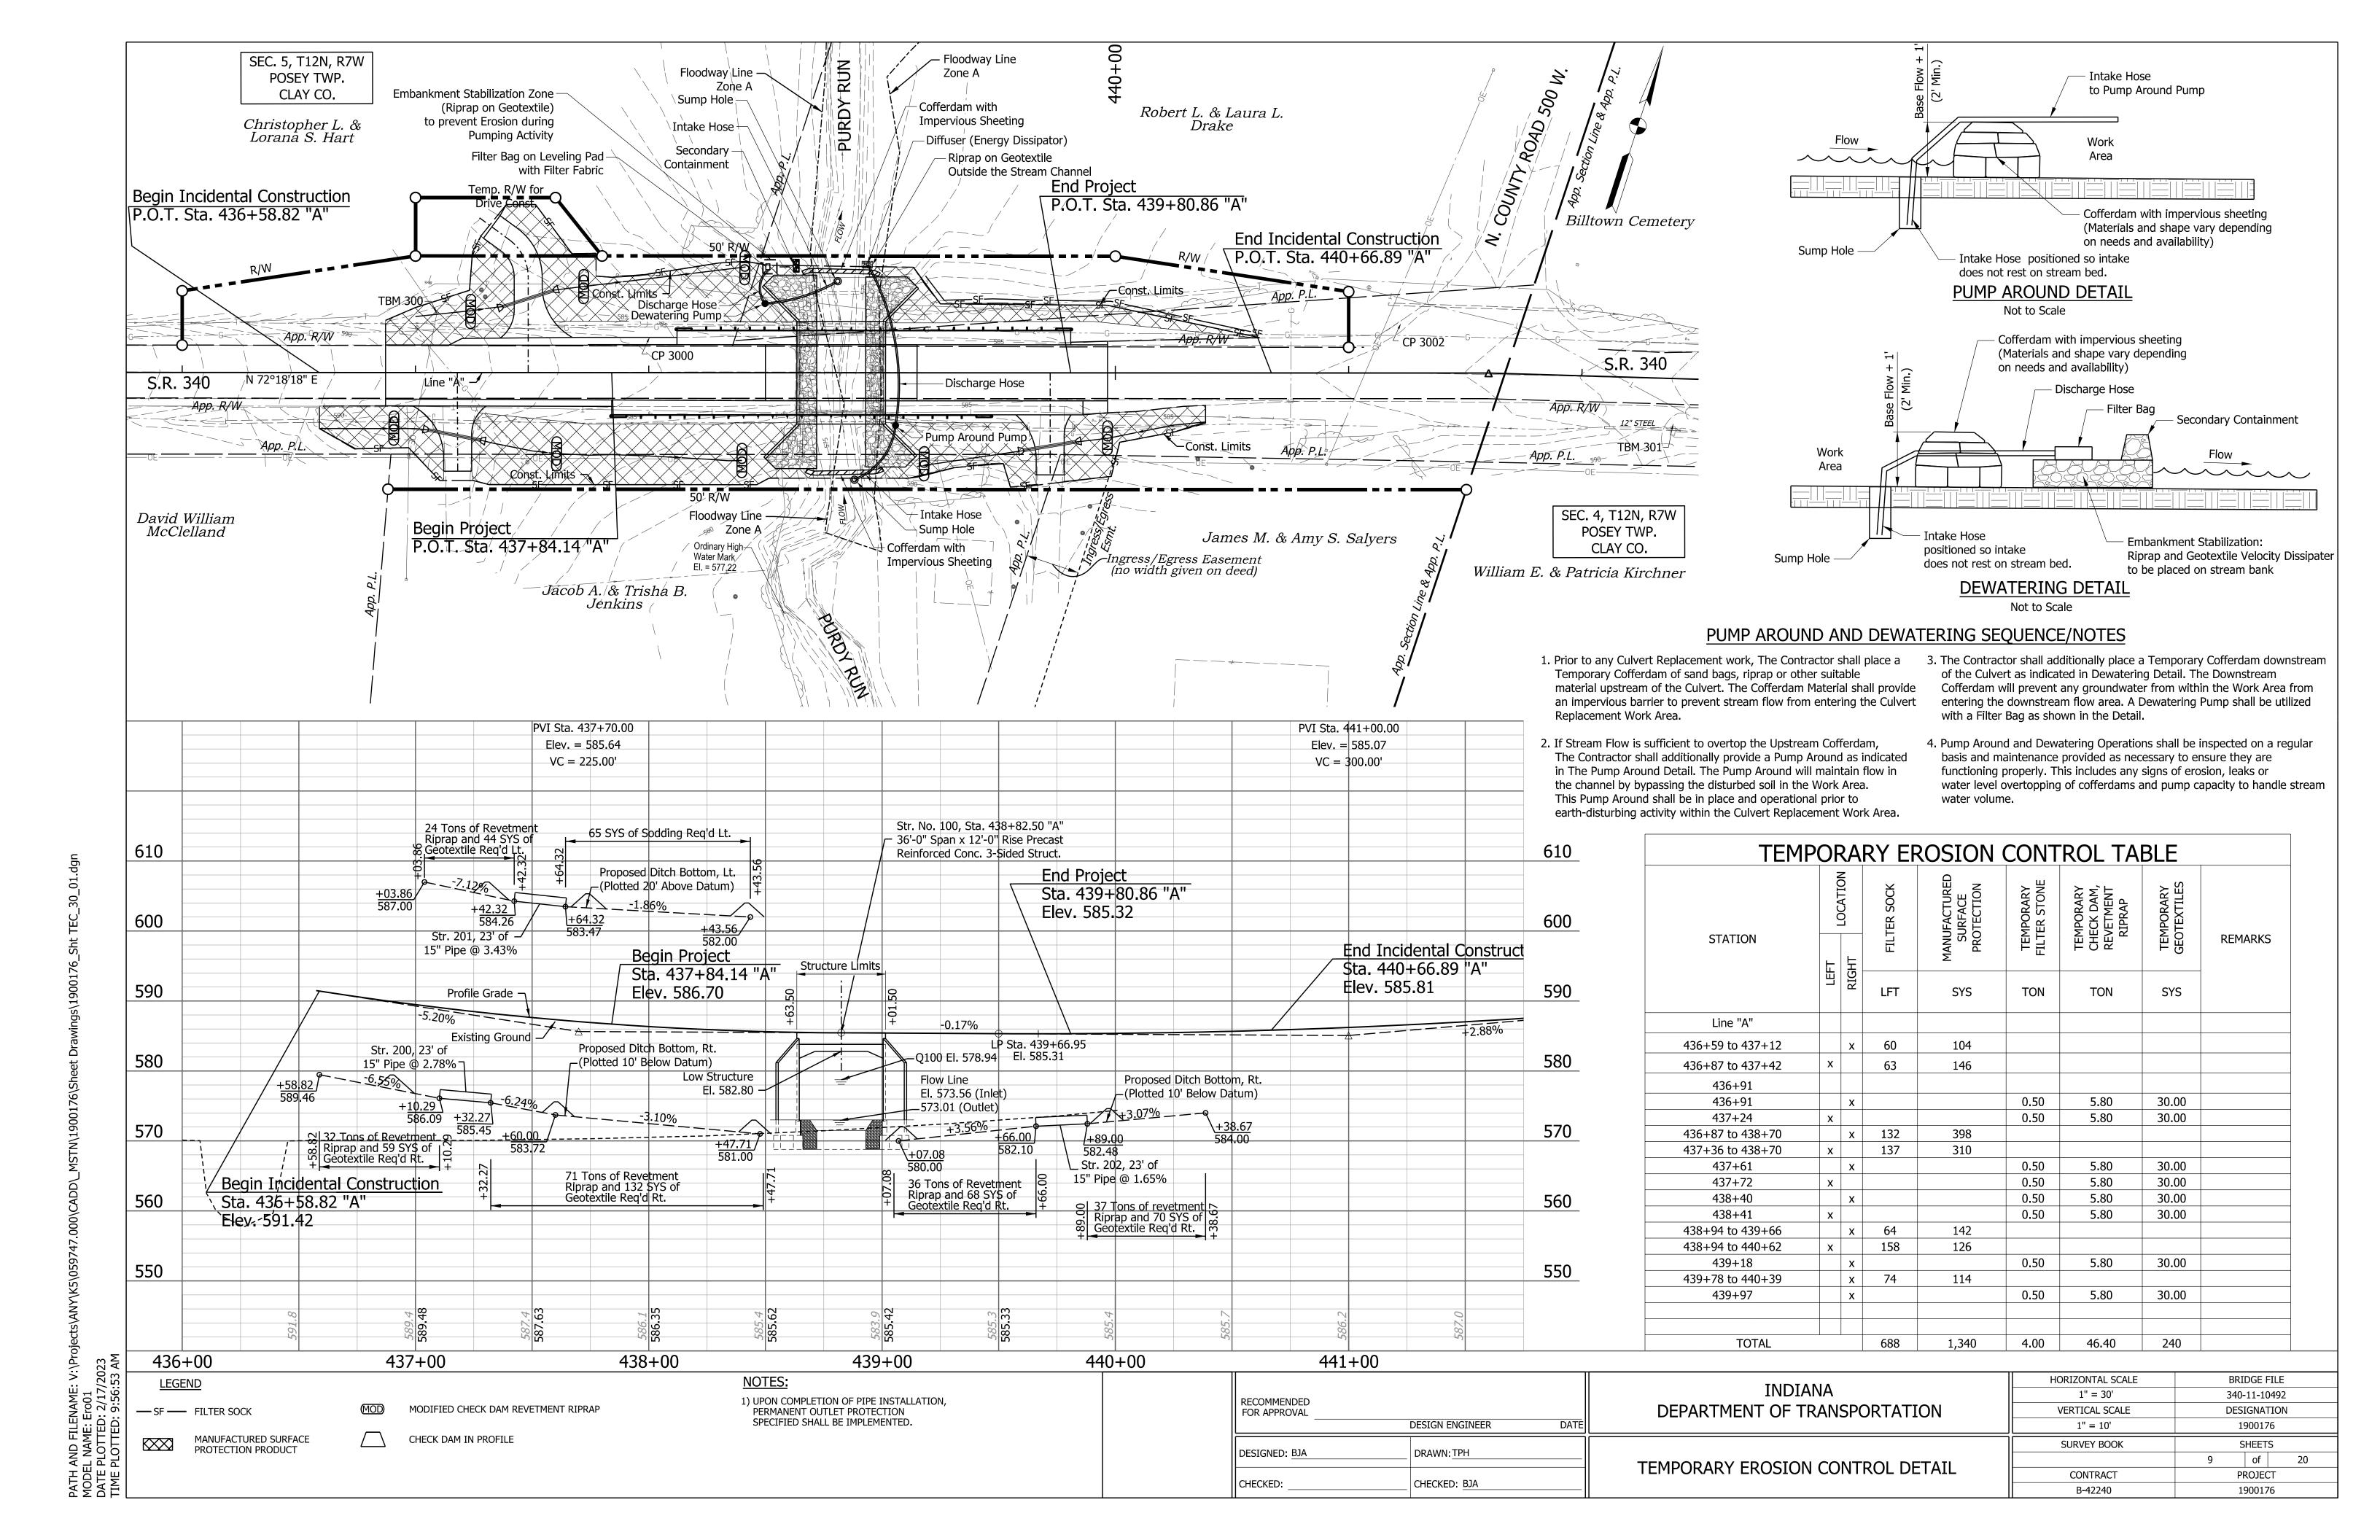

DESIGN ENGINEER

DRAWN: JPL

CHECKED: DOR

DESIGNED: JPL

CHECKED: DOR

1900176

SHEETS

of

PROJECT

1900176

10

N/A


SURVEY BOOK

CONTRACT

B-42240


GENERAL PLAN

PATH AND FILENAME: V:\Projects\ANY\K5\059747.000\CADD_MSTN\1900176\Sheet Drawings\19 MODEL NAME: Sheet Drawings\19 DATE PLOTTED: 2/17/2023

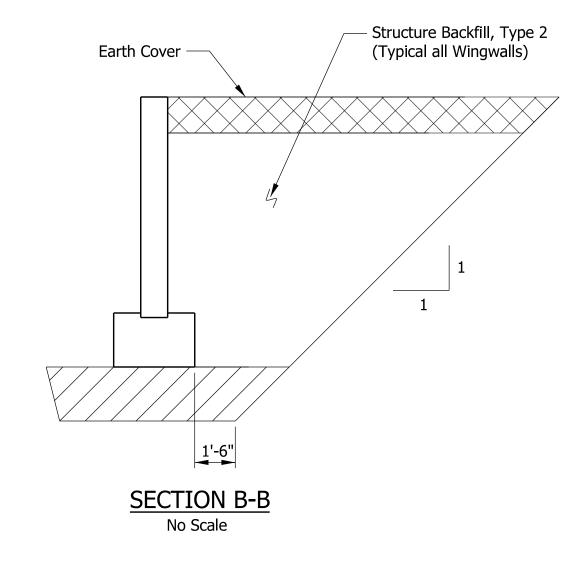

LEGEND:

- Soft Soils encountered at footing elevation should be excavated and replaced with Compacted #53 Stone.

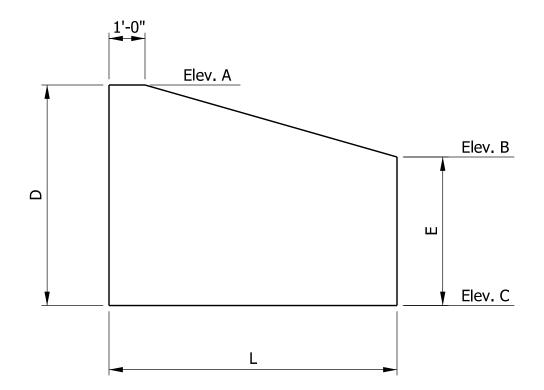

	WINGWALL TABLE														
	Wing A	Wing B	Wing C	Wing D											
Elev. A	584.96	584.85	4.85 584.96 584.85												
Elev. B	580.06	580.05	580.29	580.29											
Elev. C	570.80	570.80	571.35	571.35											
D	14.16'	14.05'	13.61'	13.50'											
E	9.26'	9.25'	8.94'	8.94'											
L	21.0'	20.0'	20.0'	19.0'	Total										
Area (SFT.)	245.9	233.0	225.5	213.2	917.6										

WINGWALL ELEVATION No Scale

WINGWALL SOIL PARAMETERS

GENERAL NOTES

All Dimensions are in feet (Ft.) except as noted.

A three-sided arch-topped or true arch structure will not be permitted at this location.

See Standard Drawing E601-MGSA for W-Beam Guardrail Installation.

See Standard Drawing E723-CCSP-03 & -04 for stream bed scour protection and sumping detail.

Contractor shall verify the Existing Flowline Elevation to set the appropriate Sump Depth.

Designers should coordinate with the Office of Hydraulics to determine the necessary adjustments to invert and top of footing elevations. Typically, if the difference between the flowline elevation shown in the plans and existing flowline is half the sump depth or greater, the structure elevations should be lowered accordingly to provide the sump as shown on the plans. If the existing flowline elevation is higher than the flowline elevation shown on the plans, no changes are required to the structure elevations.

SUMMARY OF QUANTITIES

STRUCTURE BACKFILL, TYPE 2 = 523 CYS STRUCTURE BACKFILL, TYPE 5 = 42 CYS

DESIGN DATA

Designed for HL-93 loading in accordance with AASHTO LRFD Bridge Design Specifications, Ninth Edition, 2020.

DEAD LOAD

Actual weight plus 35 lb/ft² for future wearing surface.

PRECAST REINFORCED CONCRETE THREE-SIDED STRUCTURE 36'-0" SPAN x 12'-0" RISE x 44'-0" LONG SKEW: NONE S.R. 340 OVER PURDY RUN **CLAY COUNTY**

HORIZONTAL SCALE BRIDGE FILE INDIANA AS NOTED 340-11-10492 RECOMMENDED FOR APPROVAL DEPARTMENT OF TRANSPORTATION VERTICAL SCALE DESIGNATION DESIGN ENGINEER N/A 1900176 SURVEY BOOK SHEETS DRAWN: JPL DESIGNED: JPL of 11 **GENERAL PLAN** CONTRACT PROJECT CHECKED: DOR CHECKED: DOR 1900176

	STRUCTURE DATA																																												
STRUCTURE NUMBER	STATION	LEFT NOITROOT RIGHT	CROSS	SIZE	MAI MAI	DESCRIPTION ANHOLE, INLET, CATCH BASIN, OR SPECIALTY TRUCTURE AND TYPE	=	VIDEO INSPECTION LENGTH	SKEW	COVER N MAX	UP STREAM	DOWN STREAM	SUMP DEPTH	TOP OF CASTING	SERVICE LIFE	SITE DESIGNATION	BACKFILL METHOD	STRUCTURE BACKFILL TYPE 1	STRUCTURE BACKFILL TYPE 2		FLOWABLE BACKFILL TYPE ??	EXCAVATION	AGGREGATE	23	TYPE?? (??)	RIPRAP TYPE?? (??)	REVETMENT RIPRAP	GEOTEXTILES for SORIPRAP TYPE?? (??)	REVETMENT RIPRAP ON LOS	CLASS ? RIPRAP Z	CONCRETE, CLASS A, FOR STR.	PIPE, REMOVE	VIDEO INSPECTION	PIPE END SECTION	RATED BO	X END SE	ECTION S	SAFETY M	1ETAL END	SECTION	CONNECT TO STR.	CULVERT ASS ID	SET	REMARKS	
			FT				LFT	LFT	FT	FT	ELEV.	ELEV.	IN.	ELEV.	YRS			CYS	CYS	CYS	CYS C	YS. T	ONS TO	ONS TO	NS SY	YS	TON	SYS.	TONS	TONS	CYS	LFT	LFT	EA. T	TYPE S	SLOPE	EA.	TYPE	SLOPE	EA.					
Line A											_	_																													_				
100	438+82.50		X	36' x 12'			44		0	0.62	573.56	573.01	18.00		75 N	IA 7	7		523	42																							COA	ATED	
200	437+17.97	X		15	3	Drive Pipe	23				586.09	585.45																						2											
201	437+48.32	X		15	3	Drive Pipe	23				584.26	583.47																						2											
202	439+72.08	X		15	3	Drive Pipe	23				582.48	582.10																						2											

PATH AND FILENAME: V:\Projects\ANY\K5\059747.000\CADD_MSTN\1900176\Sheet Drawings\19 MODEL NAME: Sheet DATE PLOTTED: 2/17/2023 TIME PLOTTED: 9:57:04 AM

RECOMMENDED FOR APPROVAL	DESIGN ENGINEER DATE	INDIANA DEPARTMENT OF TRANSPORTATION	HORIZONTAL SCALE VERTICAL SCALE	
DESIGNED: NAZ	DRAWN: TPH		SURVEY BOOK	
		MISCELLANEOUS TABLES	CONTRACT	12
CHECKED: BJA	CHECKED: NAZ		B-42240	

BRIDGE FILE 340-11-10492

DESIGNATION

SHEETS

of PROJECT

				P	AVED	SIDE [DITCH	l, RIP	RAP [DITCH	, AND	SOD	DING	SUM	MARY	TABL	_E				
	LOCATION					PAVED S	IDE DITCH				R	IPRAP DIT	CH				SOD	DING			NS
					S	EACH)	тот.	EQV. PAY	LNTH.			RAP			DITCHES			EAK	CONE	U	FOR LAWNS
FROM	TO STATION	LEFT	MEDIAN	ACTUAL LENGTH	CUT OFF WALLS		A	E	J	CLASS I	CLASS II	REVETMENT RIPRAP	UNIFORM RIPRAP	GEOTEXTILES	FOR PAVED SIDE DIT	FOR DITCHES	FOR MEDIAN	FOR SHOULDER BREAK	SODDING AT BRIDGE	TOTAL SODDING	NURSERY SODDING F
				LFT	EACH	EACH	LFT	LFT	LFT	TONS	TONS	TONS	TONS	SYS	SYS	SYS	SYS	SYS	SYS	SYS	SYS
Line "A"																					
437+03.86	437+42.32	X										24		44							
437+64.32	438+43.56	X														65				65	
436+58.82	437+10.29		X									32		59							
437+32.27	438+47.71		X									71		132							
439+07.08	439+66.00		X									36		68							
439+78.08	440+38.67		X									37		70							
TOTALS												200		373		65				65	

MONUMENT TABLE											
LINE	DESIGNATION	STATION	DIRECTION	MONUMENT A	MONUMENT B	MONUMENT C	MONUMENT D	SECTION CORNER	BENCH MARK POST		
				EACH	EACH	EACH	EACH	EACH	EACH		
Α		438+50.00	CL		1						
Α		439+15.00			1						
OTALS					2						

	PAVEMEN ⁻	T MARK	INGS S	SUMMARY T	TABLE
		Line,	Solid	- Raised	
LOCA	White	Yellow	Pavement Markers	NOTES	
From	То	4 in.	4 in.		
Station	Station	LFT	LFT	EACH	
Lir	ne A				
436+87.20	439+96.65	309			
436+87.20	439+96.65		309		
436+87.20	439+96.65		309		
436+87.20	439+96.65	309			
TOTALS		619	619		

ROW MARKERS								
LINE	SIDE LT/RT	STATION	OFFSET	ROW MARKER				
Α	RT	436+88.27	50.00'	1				
Α	RT	441+50.49	50.00'	1				
Α	LT	436+00.00	Ex. R/W	1				
Α	LT	436+00.00	35.00'	1				
Α	LT	437+00.00	50.00'	1				
А	LT	440+00.00	50.00'	1				
Α	LT	441+00.00	35.00'	1				
Α	LT	441+00.00	Ex. R/W	1				
	TC	TAL:		8				

MAILBOX APPROACHES								
Line	LT./RT.	C/L BOX STATION	ASSEMBLY REQ'D					
		C/L BOX STATION	SINGLE	DOUBLE				
Α	RT	436+69.00	1					
Α	RT	437+00.00	1					
Α	RT	437+50.00	1					
Α	RT	439+90.00		1				
А	RT	439+93.00	1					
		Totals	4	1				

PATH AND FILENAME: V:\Projects\ANY\K5\059747.000\CADD_MS	Σ
MODEL NAME: Sheet	
DATE PLOTTED: 2/17/2023	
TIME PLOTTED: 9:57:06 AM	

		TAIDTANIA	HORIZONTAL SCALE	BRIDGE FILE	
RECOMMENDED		INDIANA		340-11-10492	
FOR APPROVAL DESIGN ENGINEER DATE DEPARTMENT OF TRANSPORTATION		DEPARTMENT OF TRANSPORTATION	VERTICAL SCALE	DESIGNATION	
				1900176	
DECICNED NAZ	DRAMAL TRU		SURVEY BOOK	SHEETS	
DESIGNED: <u>NAZ</u>	DRAWN: TPH	MICCELLANEOUS TABLES		13 of 20	
CHECKED. DIA	CHECKED, NAZ	MISCELLANEOUS TABLES	CONTRACT	PROJECT	
CHECKED: BJA	_ CHECKED: NAZ		B-42240	1900176	

B-42240


B-42240


595 590 590 585 585 580 580 575 575 440+67 END INCIDENTAL CONSTRUCTION STA. 440+66.89 HORIZONTAL SCALE BRIDGE FILE INDIANA 1" = 10' 340-11-10492 RECOMMENDED FOR APPROVAL DEPARTMENT OF TRANSPORTATION VERTICAL SCALE DESIGNATION DATE DESIGN ENGINEER 1900176 1" = 10' SURVEY BOOK SHEETS DRAWN: TPH DESIGNED: NAZ CROSS SECTIONS LINE "A" - S.R. 340 19 of 20 CONTRACT PROJECT


CHECKED: BJA

_ CHECKED: <u>NAZ</u>

B-42240

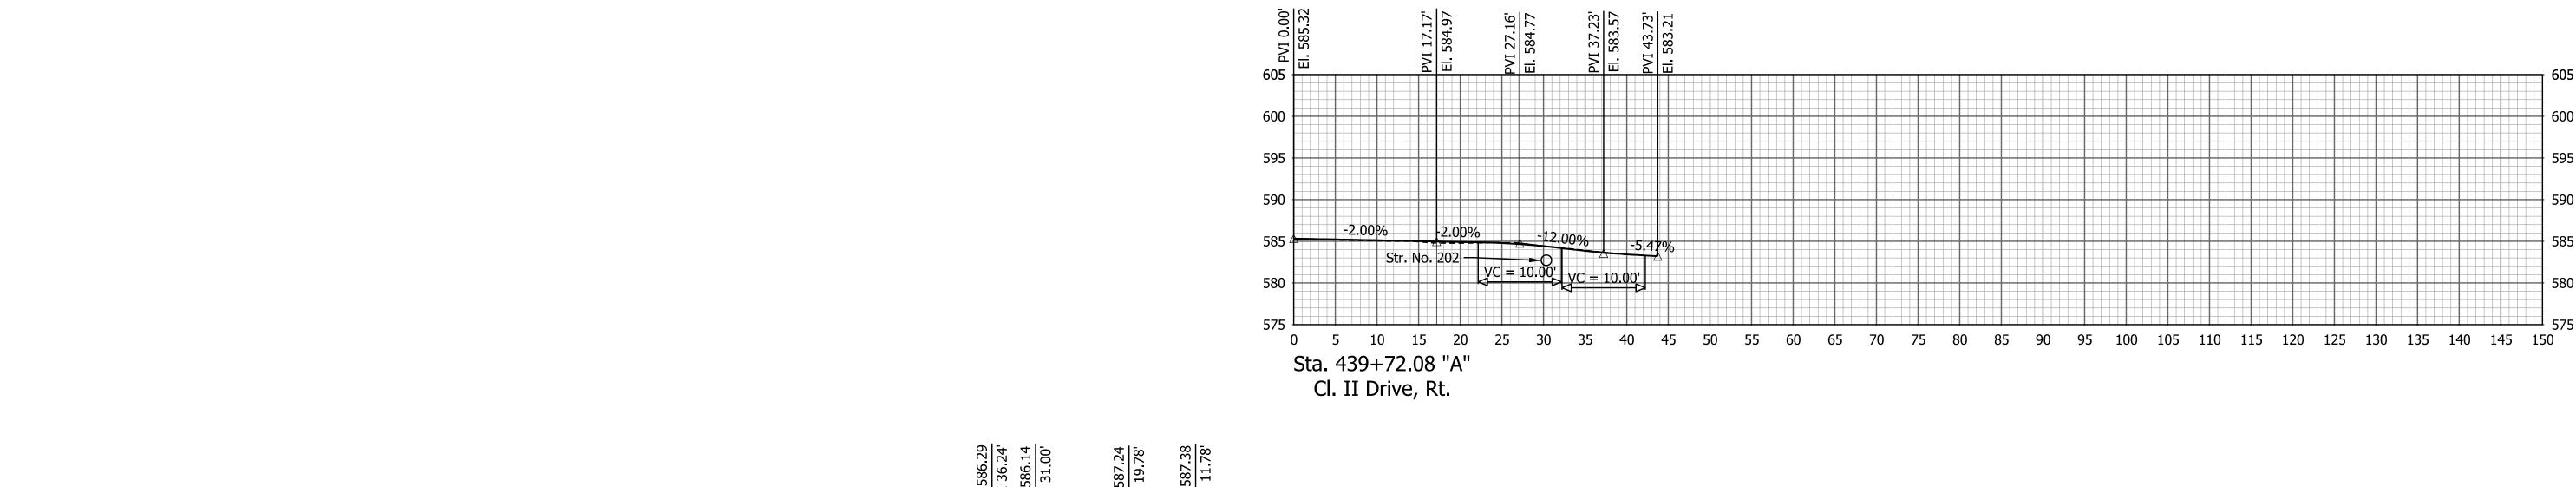

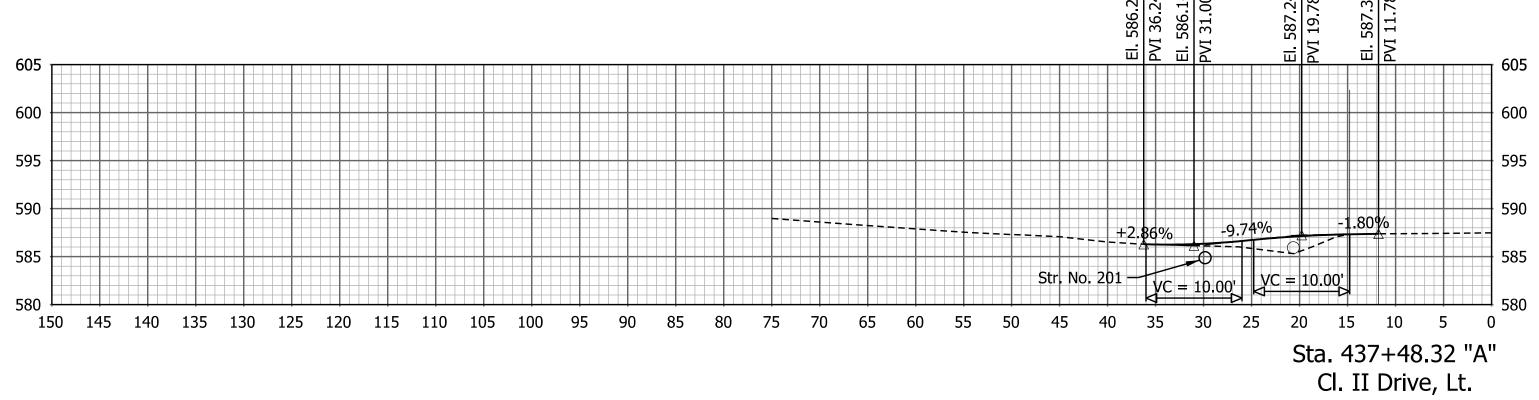

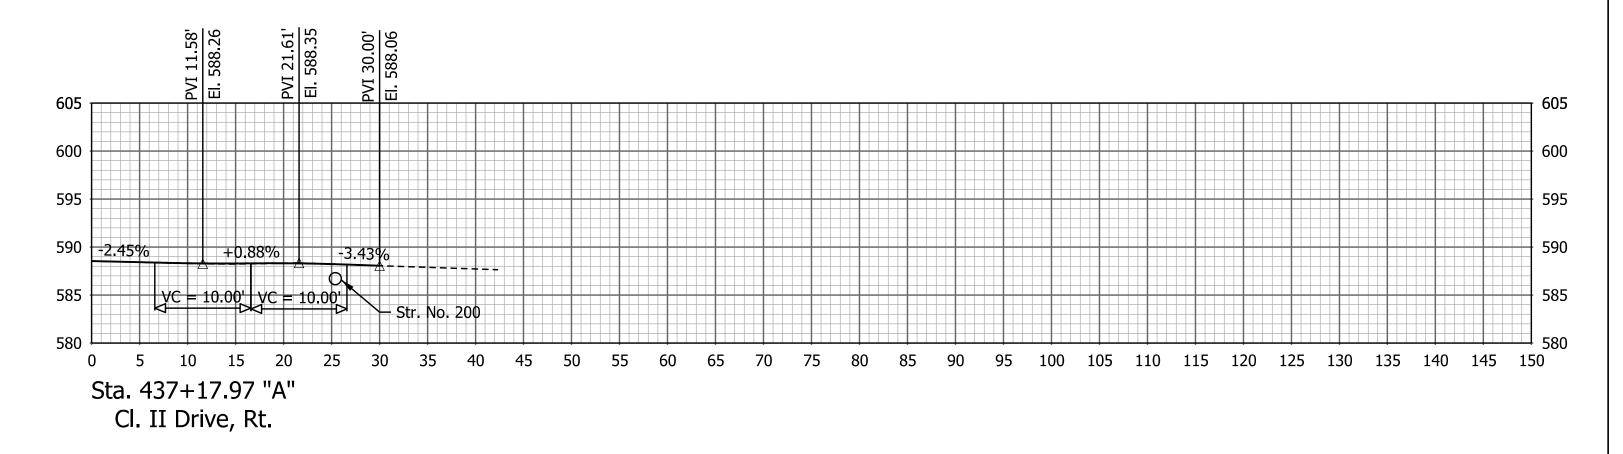

RECOMMENDED		INDIANA	HORIZONTAL SCALE 1" = 10'	BRIDGE FILE 340-11-10492		
FOR APPROVAL		DEPARTMENT OF TRANSPORTATION	VERTICAL SCALE	DESIGNATION		N
	DESIGN ENGINEER DATE		1" = 10'		1900176	
DECICNED, NAZ	DD AMAN, TDLI		SURVEY BOOK	SHEETS		
DESIGNED: NAZ	DRIVE PROFILE	DDIVE DDOEILEC		20	of	20
CHECKED, DIA	CHECKED, NAZ	DRIVE PROFILES	CONTRACT	PROJECT		
CHECKED: BJA	CHECKED: NAZ		B-42240	1900176		